

Tel: (914) 763-3822 Fax: (914) 533-0097 Email: zoning@Lewisborogov.com

AGENDA

Wednesday, September 28, 2022, 7:30 P.M.

79 Bouton Road, South Salem, Justice Court

I. Review and adoption of the Minutes of August 24, 2022

II. PUBLIC HEARING

Zoning Board of Appeals

South Salem, New York 10590

79 Bouton Road

CAL. NO. 21-22-BZ Continued from August 24, meeting.

Application of Darren P. Mercer, Architect, PLLC [Marschke, Brett A. & Rima T., owner of record], 31 East Ridge Road, Waccabuc, NY for the following variance of the proposed pool cabana/storage barn and is requesting total square footage of 1,296' whereas 600' is allowed per Article IV Section 220-23E of the Town of Lewisboro Zoning Code.

The property is located on the east side of (#31) East Ridge Road, South Salem, NY designated on the Tax Map as Sheet 0025, Block 10803, Lot 062, in an R-2AC, Two Acre Residential District consisting of approximately 3.70 acres.

CAL. NO. 25-22-BZ

Application of Whitman, Don, [Whitman, William W. & Whitman, Donald R., owner of record], 21C Boutonville Road South, Cross River, NY for the following variance of the proposed detached garage and is requesting a total square footage of 698' whereas 600' is allowed per Article IV Section 220-23E of the Town of Lewisboro Zoning Code

The property is located on the north side of (#21) Boutonville Road, Cross River, NY designated on the Tax Map as Sheet 0018, Block 10528, Lot 007, in an R-1AC, One Acre Residential District consisting of approximately 4.81 acres.

CAL. NO. 26-22-BZ

Application of Joshua Hadar [The Joshua D. Hadar Family Trust, owner of record], 20 Manor Drive, Goldens Bridge, NY for the following variance of the proposed detached studio and is requesting a total square footage of 2412' whereas 600' is allowed per Article IV Section 220-23E of the Town of Lewisboro Zoning Code, the applicant is proposing a detached studio home occupation space and is requesting a total square footage of 2412' whereas 500' is allowed per Article IV Section 220-23E.

The property is located on the north side of (#20) Manor Drive, Goldens Bridge, NY designated on the Tax Map as Sheet 0007 Block 11137 Lot 166 & 165, in a 2-AC, Two-Acre Residential District, consisting of approximately 13.21 acres.

CAL. NO. 27-22-BZ

Application of Plug In Stations, Brian Fetterman, [Cipes, Stephen, owner of record, Goldens Bridge Shopping Center], 104 Route 22, Goldens Bridge, NY for the following variance of the proposed EV charging stations with associated electrical structures and is requesting a front yard setback of 3'10" whereas 20' are required per Article IV Section 220-24E of the Town of Lewisboro Zoning Code.

The property is located on the east side of (#104) Route 22, Goldens Bridge, NY designated on the Tax Map as Sheet 0004, Block 11126, Lot 007, in an RB, Retail Business District consisting of approximately 8.961 acres.

III. CORRESPONDENCE & GENERAL BUSINESS

IV. NEXT MEETING

October 26, 2022

V. ADJOURN MEETING

(914) 763-3822 FAX (914) 875-9148 TTY 800-662-1220 Email: <u>zoning@lewisborogov.com</u> www.lewisborogov.com



TOWN OF LEWISBORO Zoning Department 79 Bouton Road South Salem, NY 10590

TOWN OF LEWISBORO, WESTCHESTER COUNTY

ZONING DEPARTMENT

| ZONING BOARD OF APPEALS – September 28, 2022 | | | | | | |
|--|--------------|----------------|--|--|--|--|
| <u>APPLICANT</u> | <u>CAL #</u> | <u>PAGE(S)</u> | | | | |
| Mercer/Marschke | 21-22-BZ | 4 TO 18 | | | | |
| Whitman | 25-22-BZ | 19 TO 23 | | | | |
| Hadar | 26-22-BZ | 24 TO 30 | | | | |
| Plug In Stations/Cipes | 27-22-BZ | 31 TO 49 | | | | |
| | | | | | | |
| | | | | | | |
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Tel: (914) 763-3060 Fax: (914) 875-9148 Email: jfarrell@lewisborogov.com

Zoning Denial 7/15/2022

<u>The Marschke Residence</u> <u>31 East Ridge Rd, Waccabuc</u> 0025-10803-062

The applicant is proposing a pool cabana/storage barn and is requesting total square footage of 1190' whereas 600' is allowed per Article IV Section 220-23E of the Town of Lewisboro Zoning Code.

Building Inspector

Jeff Farrell

Building Department 79 Bouton Road South Salem, New York 10590

ZONING BOARD OF APPEALS

NOTICE OF PUBLIC HEARINGS

NOTICE IS HEREBY GIVEN, that the Zoning Board of Appeals of the Town of Lewisboro will host a Public Hearing on Wednesday, September 28, 2022, at 7:30 p.m., 79 Bouton Road, South Salem, New York, Justice Court.

CAL. NO. 25-22-BZ


Application of Whitman, Don, [Whitman, William W. & Whitman, Donald R., owner of record], 21C Boutonville Road South, Cross River, NY for the following variance of the proposed detached garage and is requesting a total square footage of 698' whereas 600' is allowed per Article IV Section 220-23E of the Town of Lewisboro Zoning Code

The property is located on the north side of (#21) Boutonville Road, Cross River, NY designated on the Tax Map as Sheet 0018, Block 10528, Lot 007, in an R-1AC, One Acre Residential District consisting of approximately 4.81 acres.

Additional information regarding this application may be obtained from the Secretary to the Zoning Board of Appeals, 79 Bouton Road, South Salem, New York during regular business hours. At such Hearing, all interested parties may attend and will be heard.

Dated this 31st day of August 2022 in South Salem, New York ZONING BOARD OF APPEALS TOWN OF LEWISBORO By: ROBIN PRICE, JR. CHAIR

The Town of Lewisboro is committed to equal access for all citizens. Anyone needing accommodations to attend or participate in this meeting is encouraged to notify the Secretary to the Zoning Board of Appeals in advance.

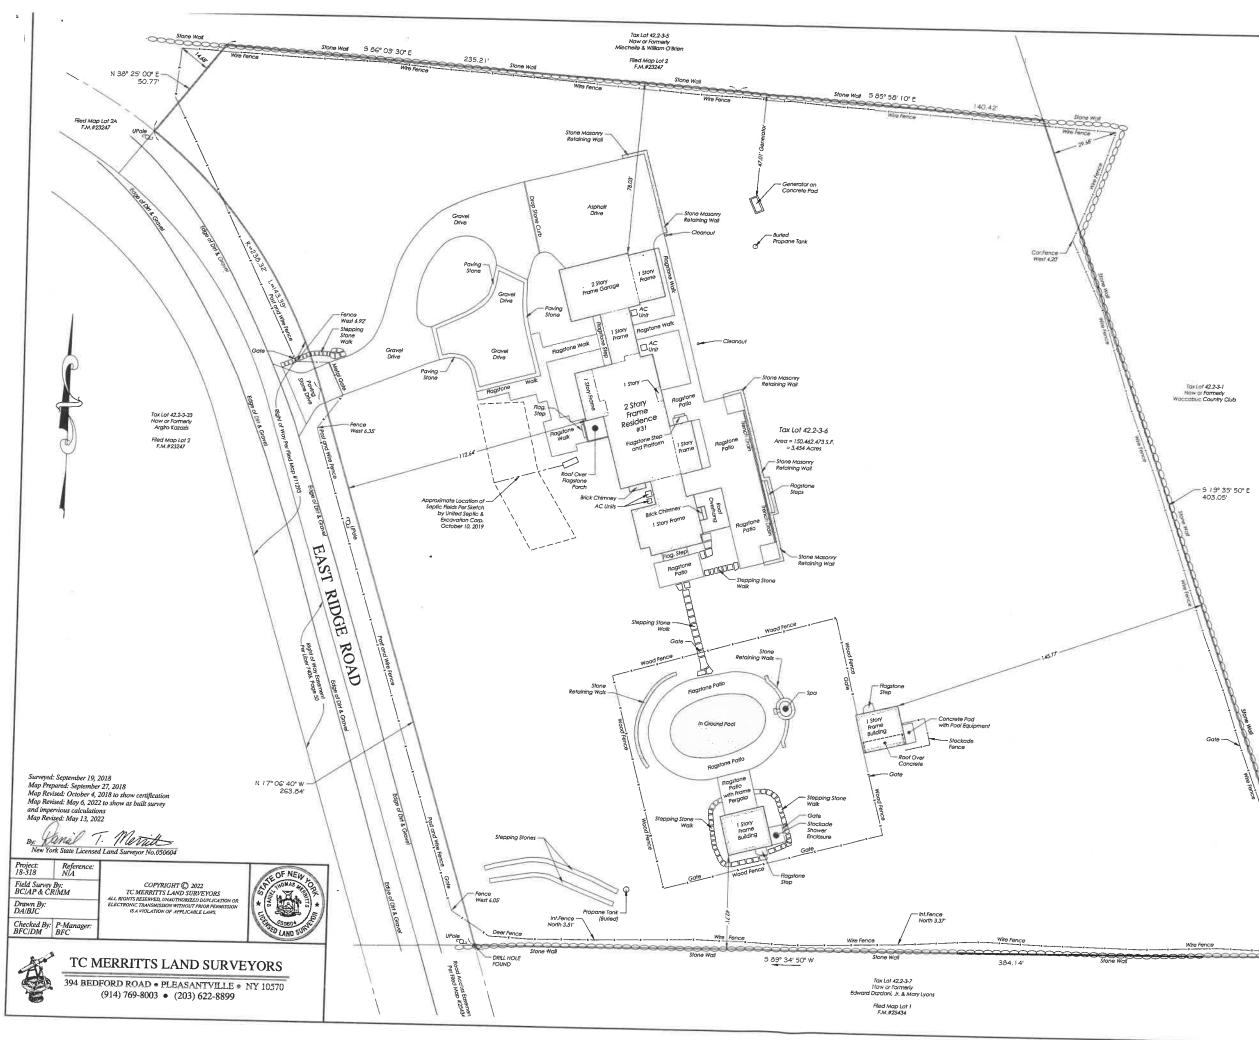

Only copies from the original of this survey marked with an original of the Land Surveyors embossed seal shall be considered to be true, valid copies.

Said certifications shall run only to the person for whom this survey is prepared and on his/her behalf to the title company, governmental agency and lending institutions listed hereon. Certifications are not transferable to additional institutions or subsequent owners.

Unauthorized alteration or addition to a survey map bearing a licensed Land Surveyors seal is a violation of Section 7209, Subdivision 2 of the New York State Education Law.

Possession only where indicated.

Adjacent property lines and easements not surveyed or certified. Access to adjacent rights of way, easements and public or private lands not guaranteed or certified.

Underground utilities shown hereon are approximate and should be verified before excavating. Additional underground utilities are not shown or certified.

Encroachments and structures below grade, if any, not shown or certified. Subject to covenants, easements, restrictions, conditions and agreen of record.

Surveyed in accordance with Deed Liber 7436, Page 564.

Premises shown hereon designated on the Town of Lewisboro Tax Maps as: Section 42.2, Block 3, Lot 6.

Property Address: 31 East Ridge Road Waccabuc, NY 10597

THIS MAP IS FOR BUILDING DEPARTMENT PURPOSES ONLY. MAP IS NOT TO BE USED FOR TITLE TRANSFER PURPOSES. MAP MAY NOT BE CERTIFIED TO TITLE COMPANIES AND/OR BANKS.

EXISTING IMPERVIOUS SURFACES - R-2A ZONE

| ENGINE ENGINE ENGINE SURFACED - K-ZA ZONE | | | | |
|---|-----------------|--|--|--|
| BUILDINGS 5,223.12 | | | | |
| DRIVEWAYS | 3,021.66 S.F. | | | |
| PORCHES AND DECKS | 108.41 S.F. | | | |
| POOLS | 1.038.57 S.F. | | | |
| WALKS AND PATIOS | 5,464.00 S.F. | | | |
| WALLS | 367.68 S.F. | | | |
| UTILITIES | 97.03 S.F. | | | |
| EXISTING TOTAL IMPERVIOUS SURFACE | 15,320.47 S.F. | | | |
| TOTAL LOT AREA | 150,462.47 S.F. | | | |
| EXISTING % IMPERVIOUS SURFACE | 10.18% | | | |
| TOTAL EXISTING BUILDING COVERAGE | 5,223.12 S.F | | | |
| EXISTING BUILDING COVERAGE (MAX. ALLOWED = 9%) | 3.47% | | | |
| | | | | |

S 19° 35' 50" E 403.05'


Wire Fence

AS BUILT SURVEY PREPARED FOR BRETT A. MARSCHKE AND RIMA T. MARSCHKE SITUATE IN THE TOWN OF LEWISBORO WESTCHESTER COUNTY, NEW YORK


> *SCALE:* $I^{n} = 20^{n}$ GRAPHIC SCALE

> > (IN FEET) 1 inch = 20 ft.

Stone Wal

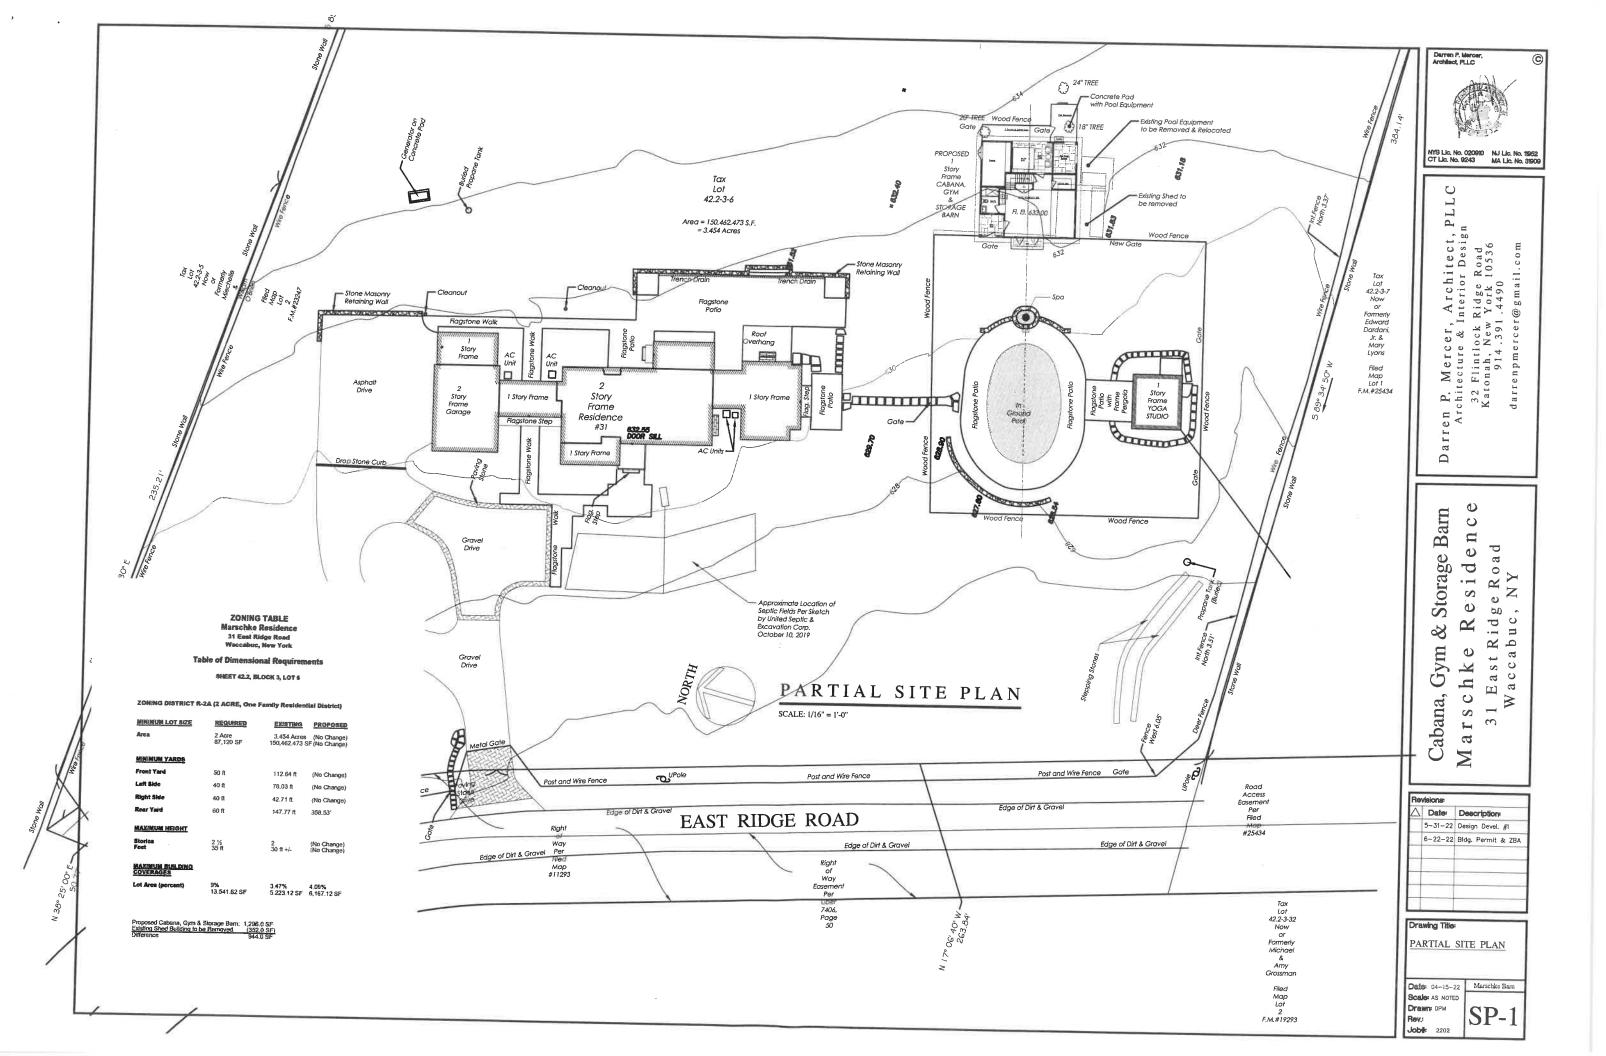





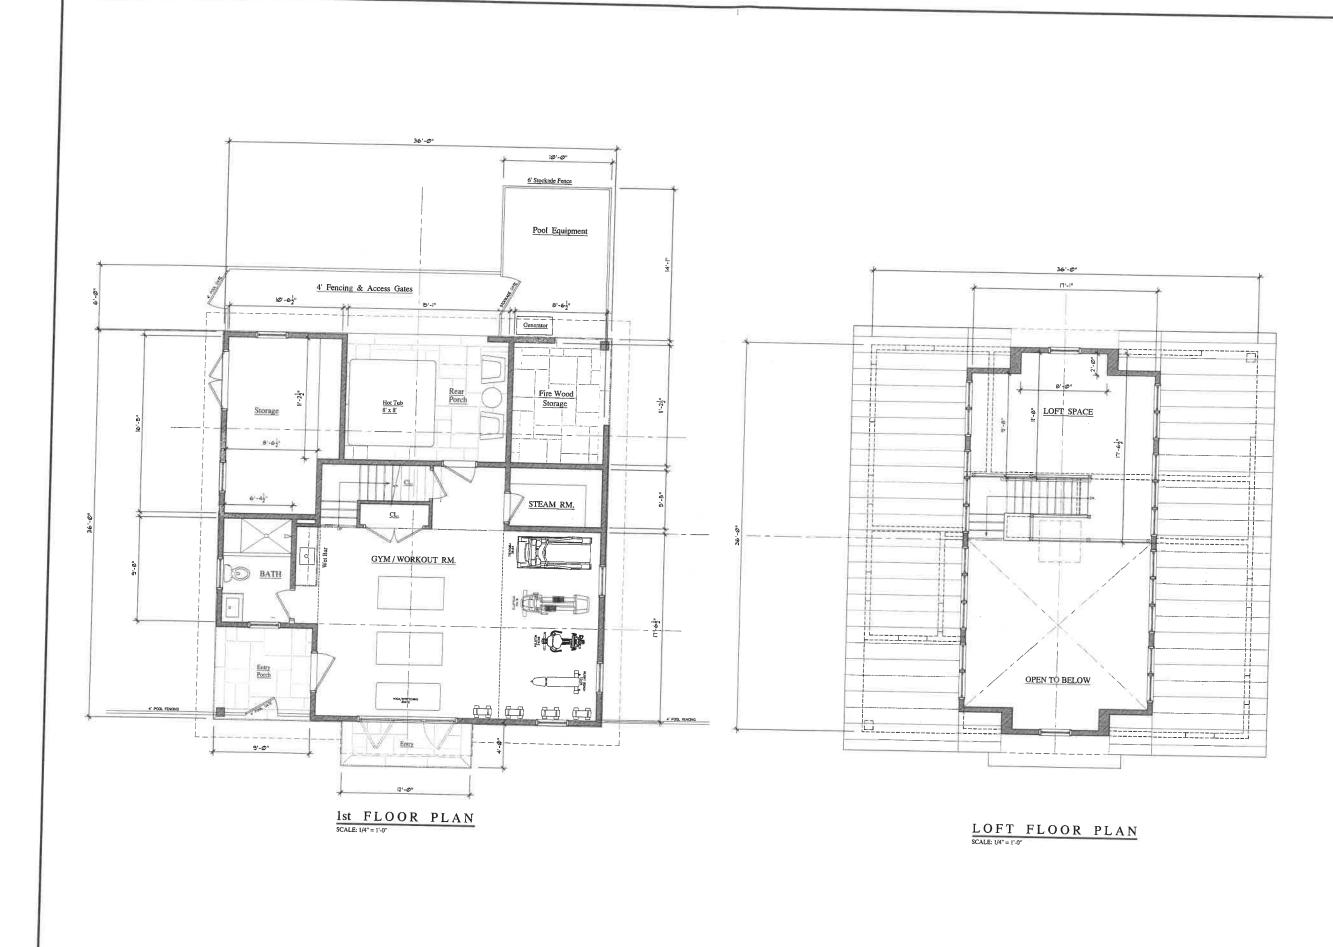



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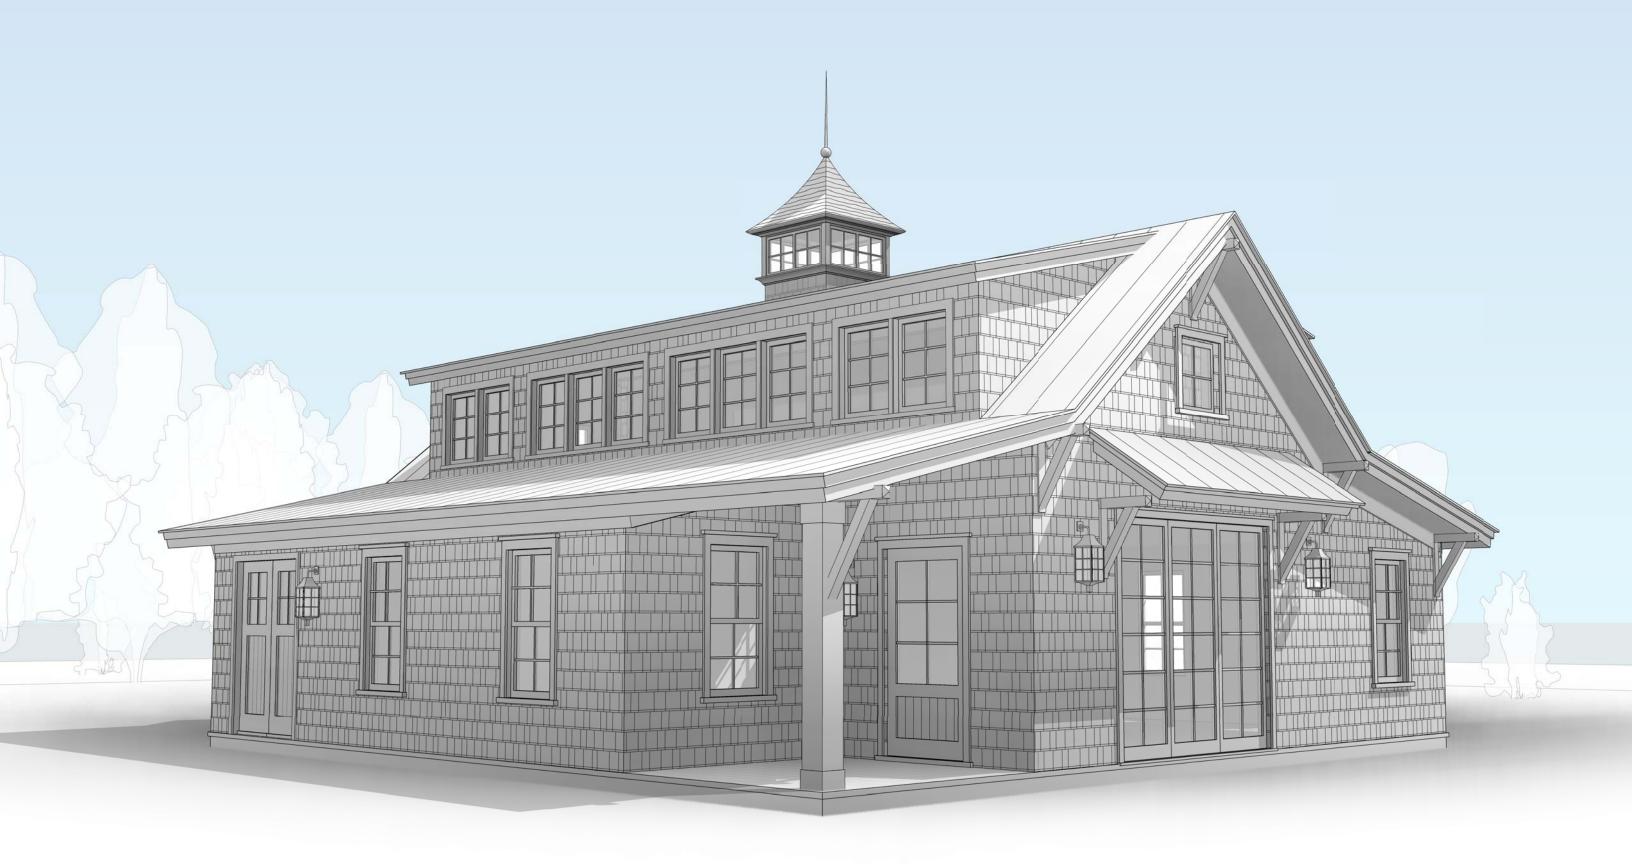
| | Derren P. Mercer, Architect, PLLC | © |
|---------------------|--|-------------|
| | MYS Lie. No. 020910 NJ Lie. No. 15 CT Lie. No. 020910 MJ Lie. No. 15 | 952 1909 |
| | Darren P. Mercer, Architect, PLLC Architecture & Interior Design 32 Flintlock Ridge Road Katonah, New York 10536 914.391.4490 darrenpmercer@gmail.com | |
| | Cabana, Gym & Storage Barn M a r s c h k e R e s i d e n c e ³¹ East R i d g e R o a d W a c c a b u c, N Y | |
| | Asions: Date: Description: 5-31-22 Design Devel. #1 6-22-22 Sids. Permit & ZSA 4 4 4 4 4 4 4 4 4 4 4 4 4 | |
| 1st LC | wing Title: FLOOR PLAN DFT FLOOR PLAN # 04-15-22 Marschke Barn | |
| Scal Dra Rev. | AS NOTED | |




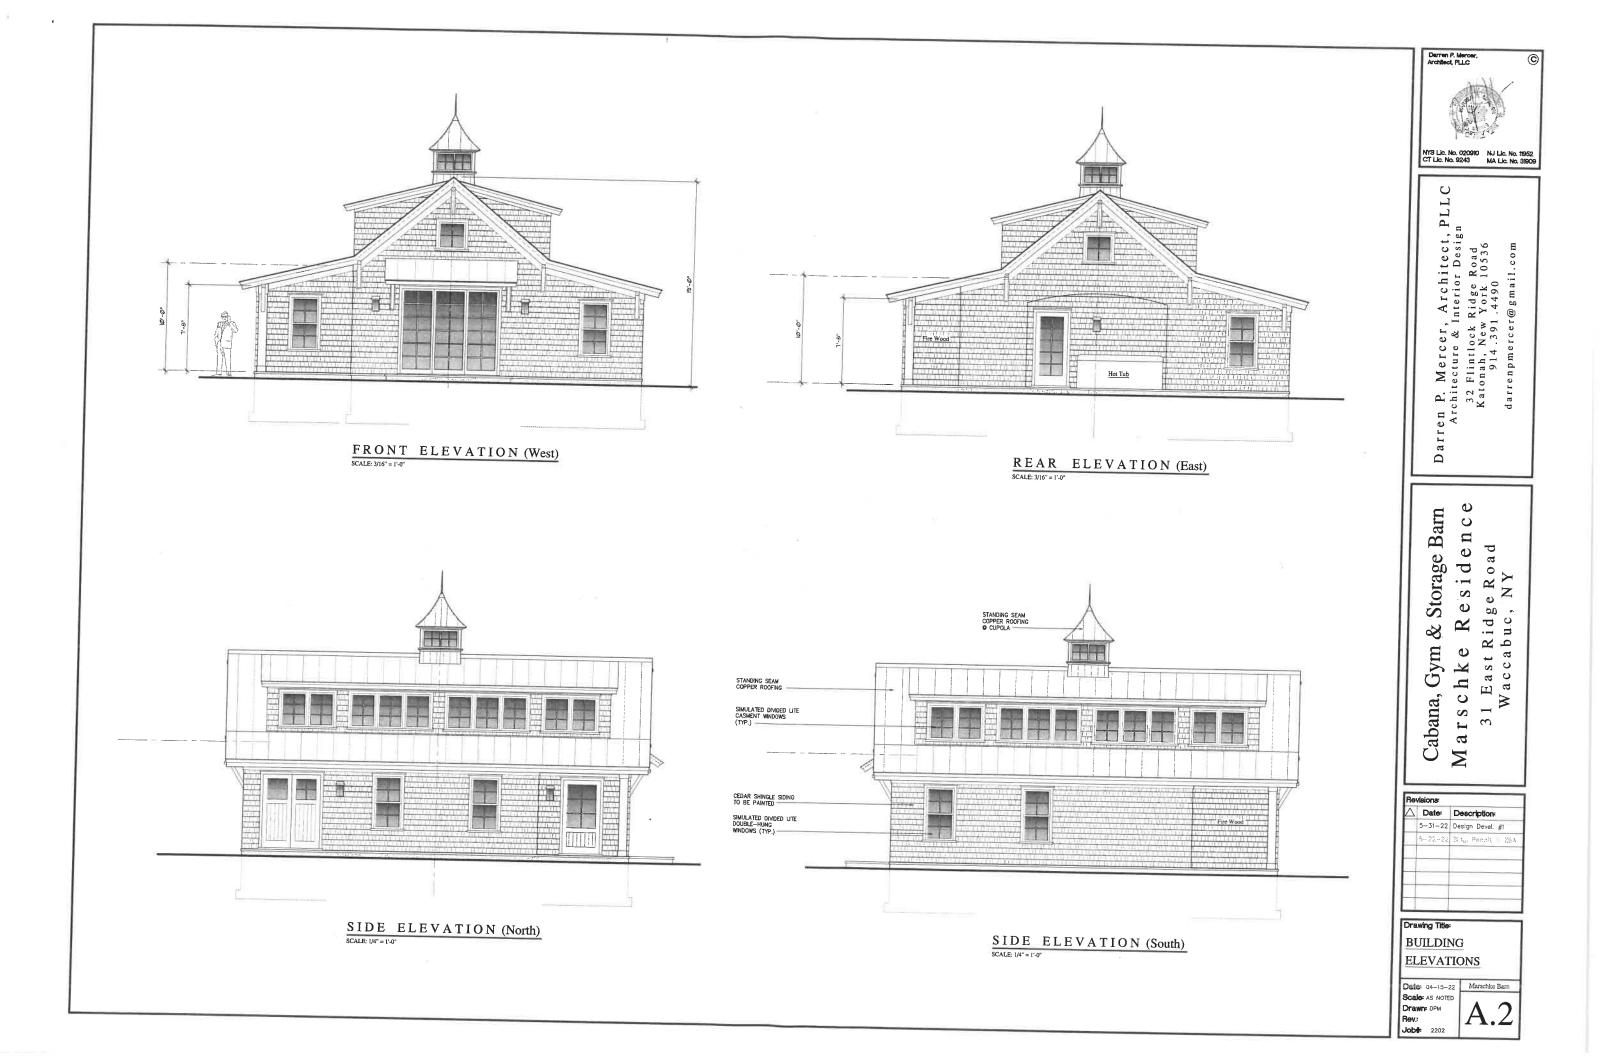


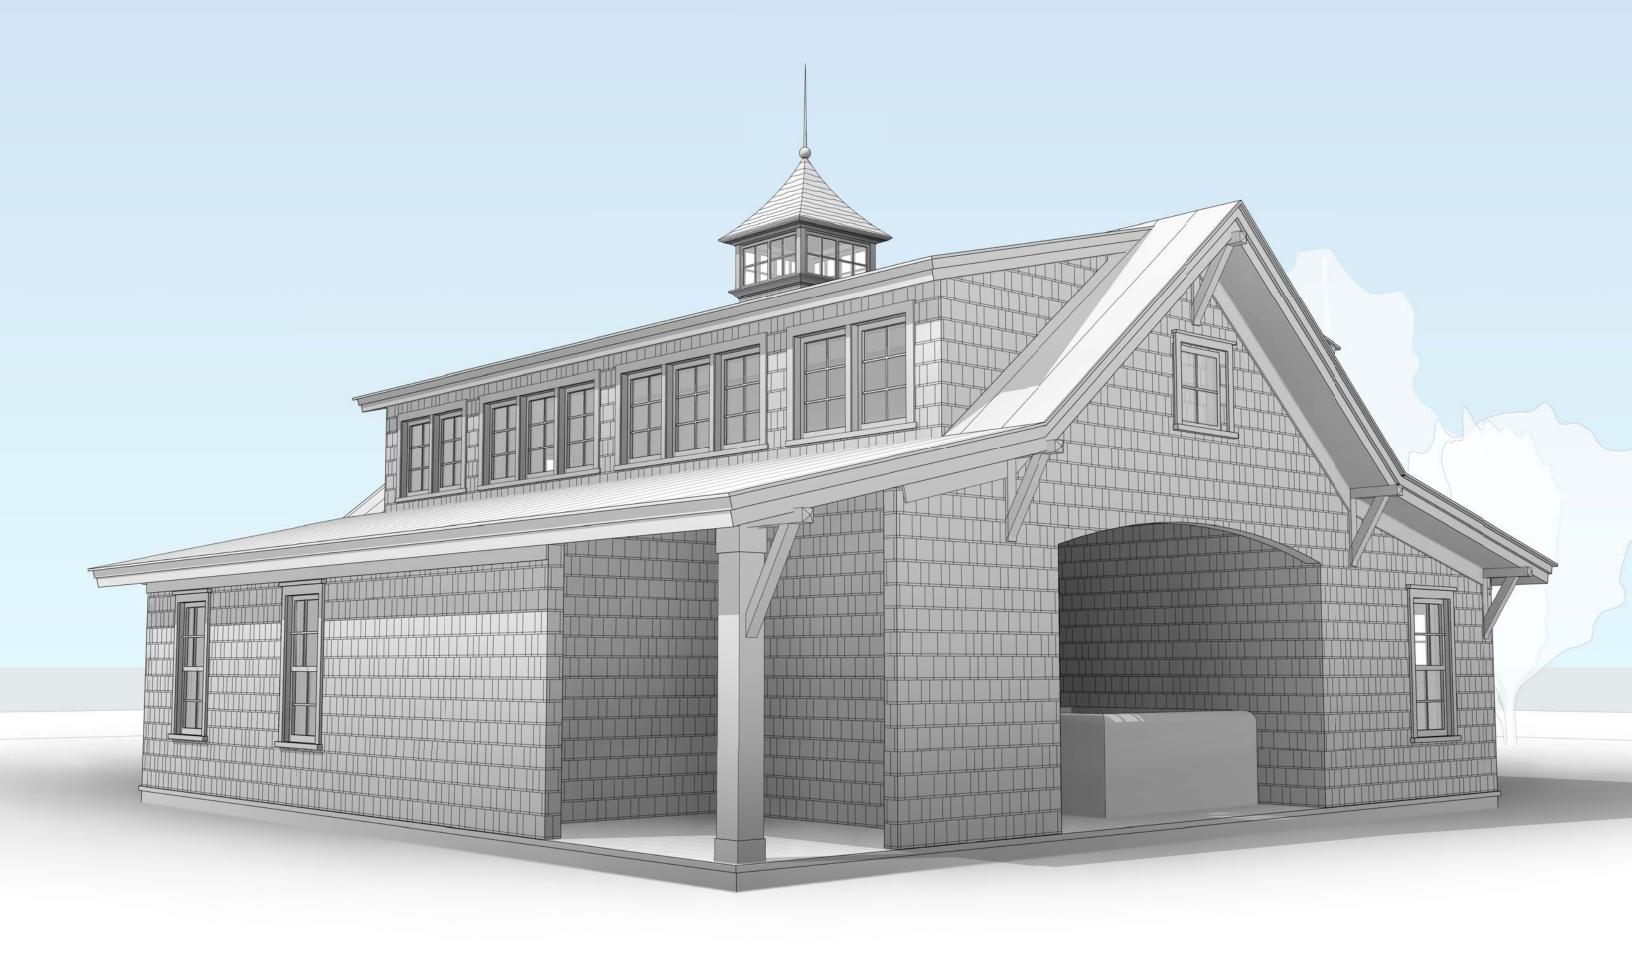

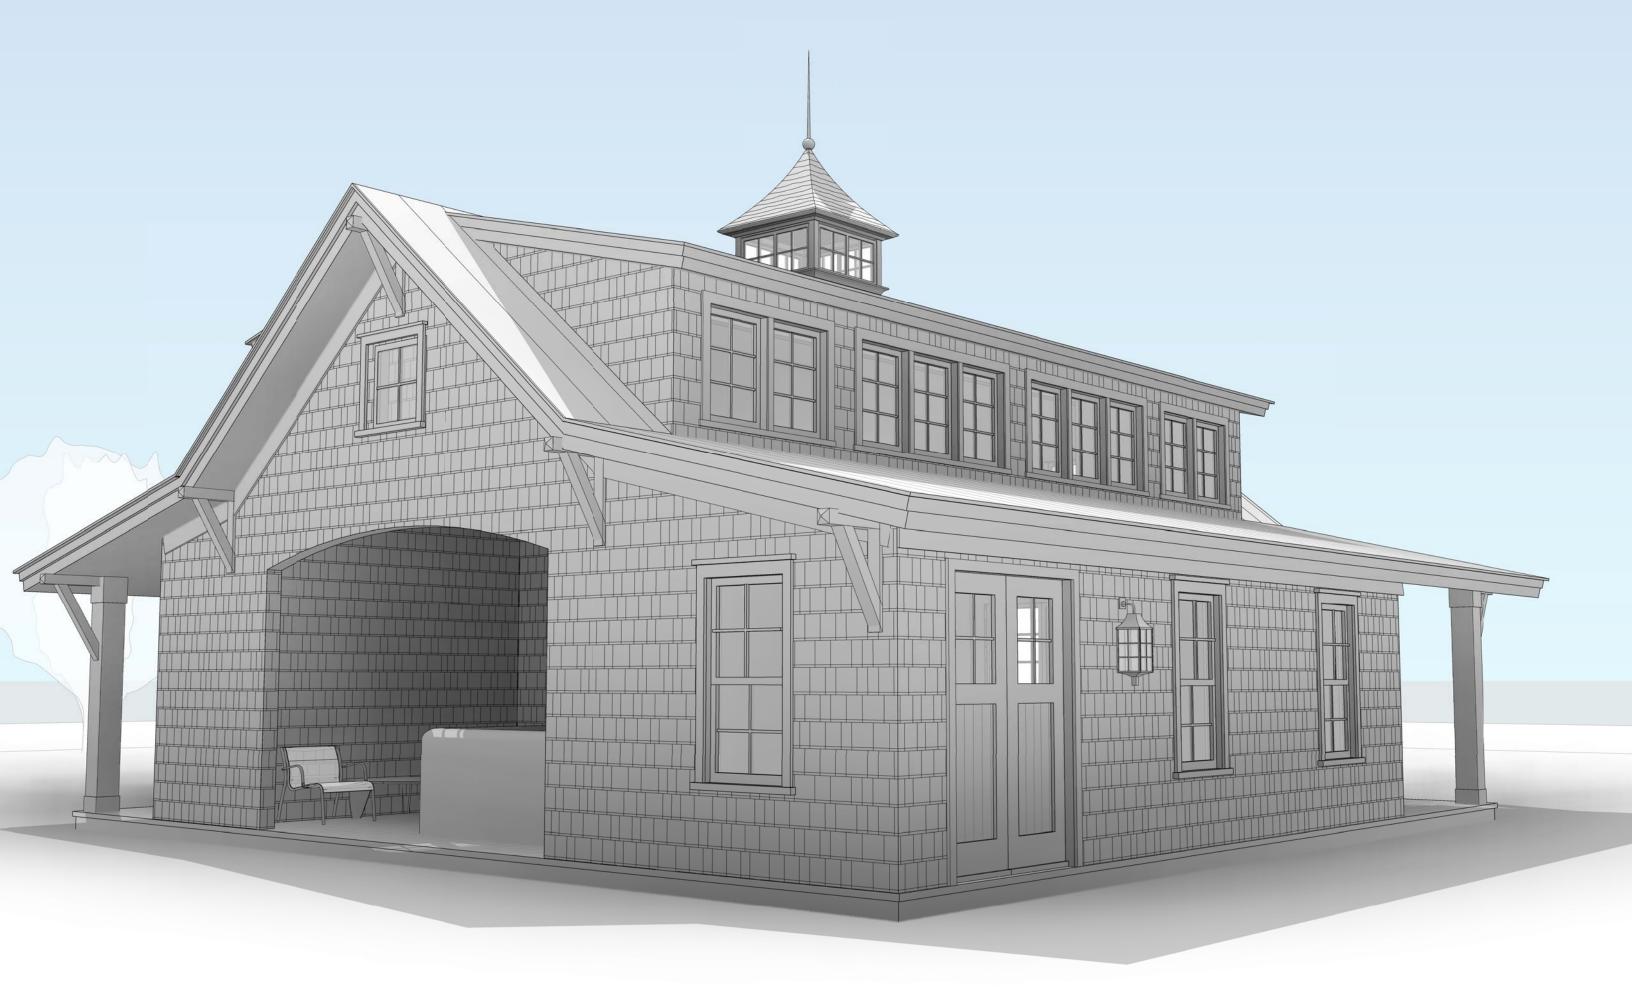

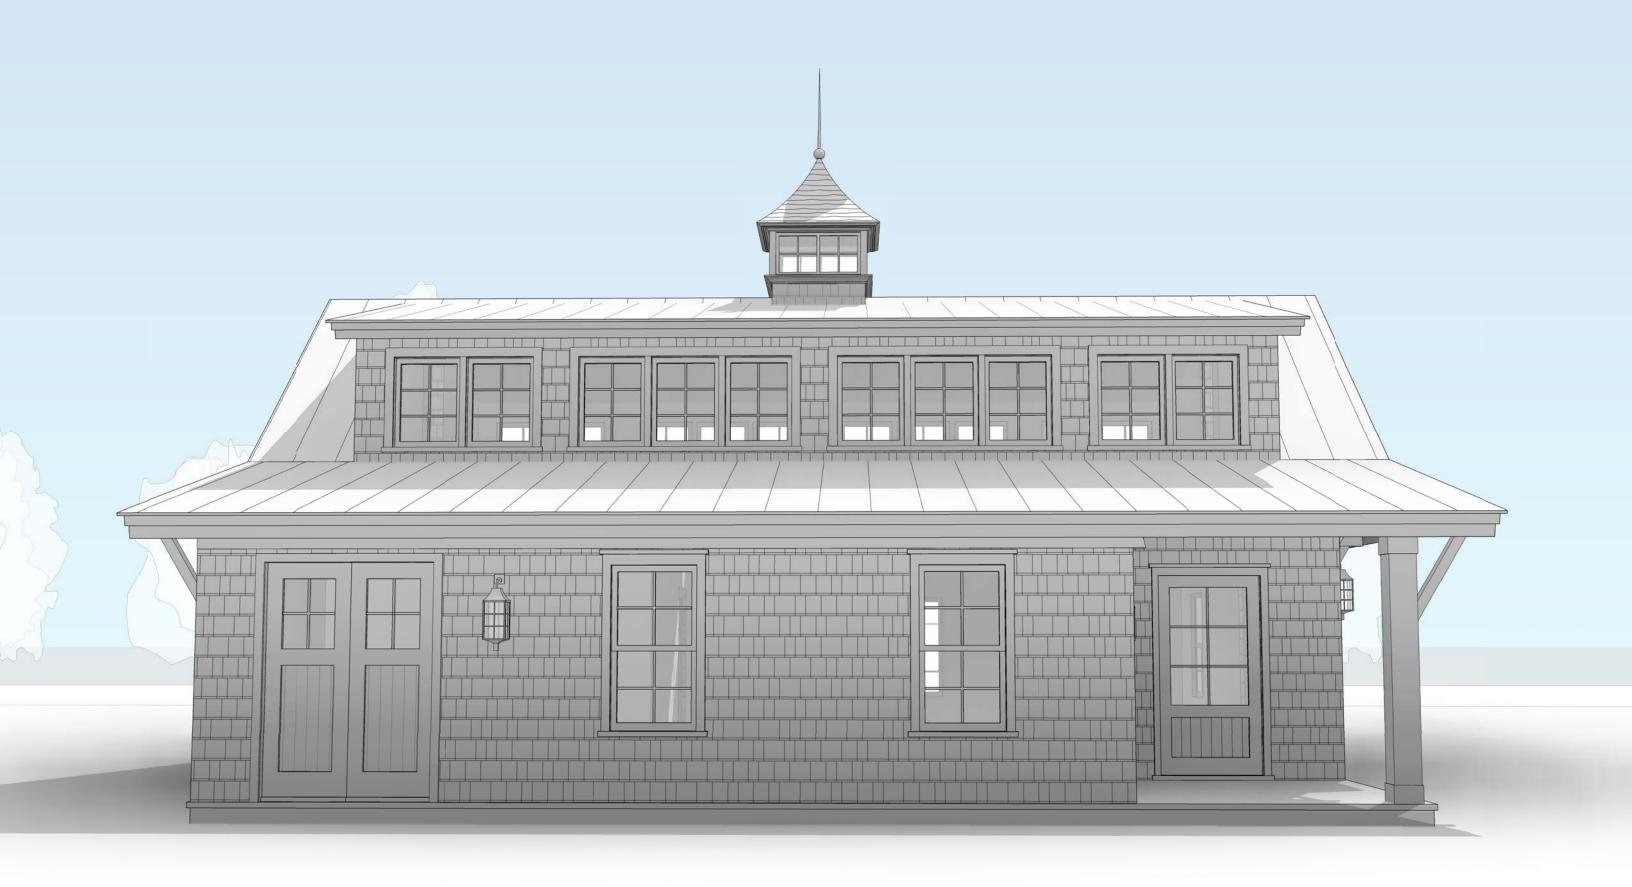

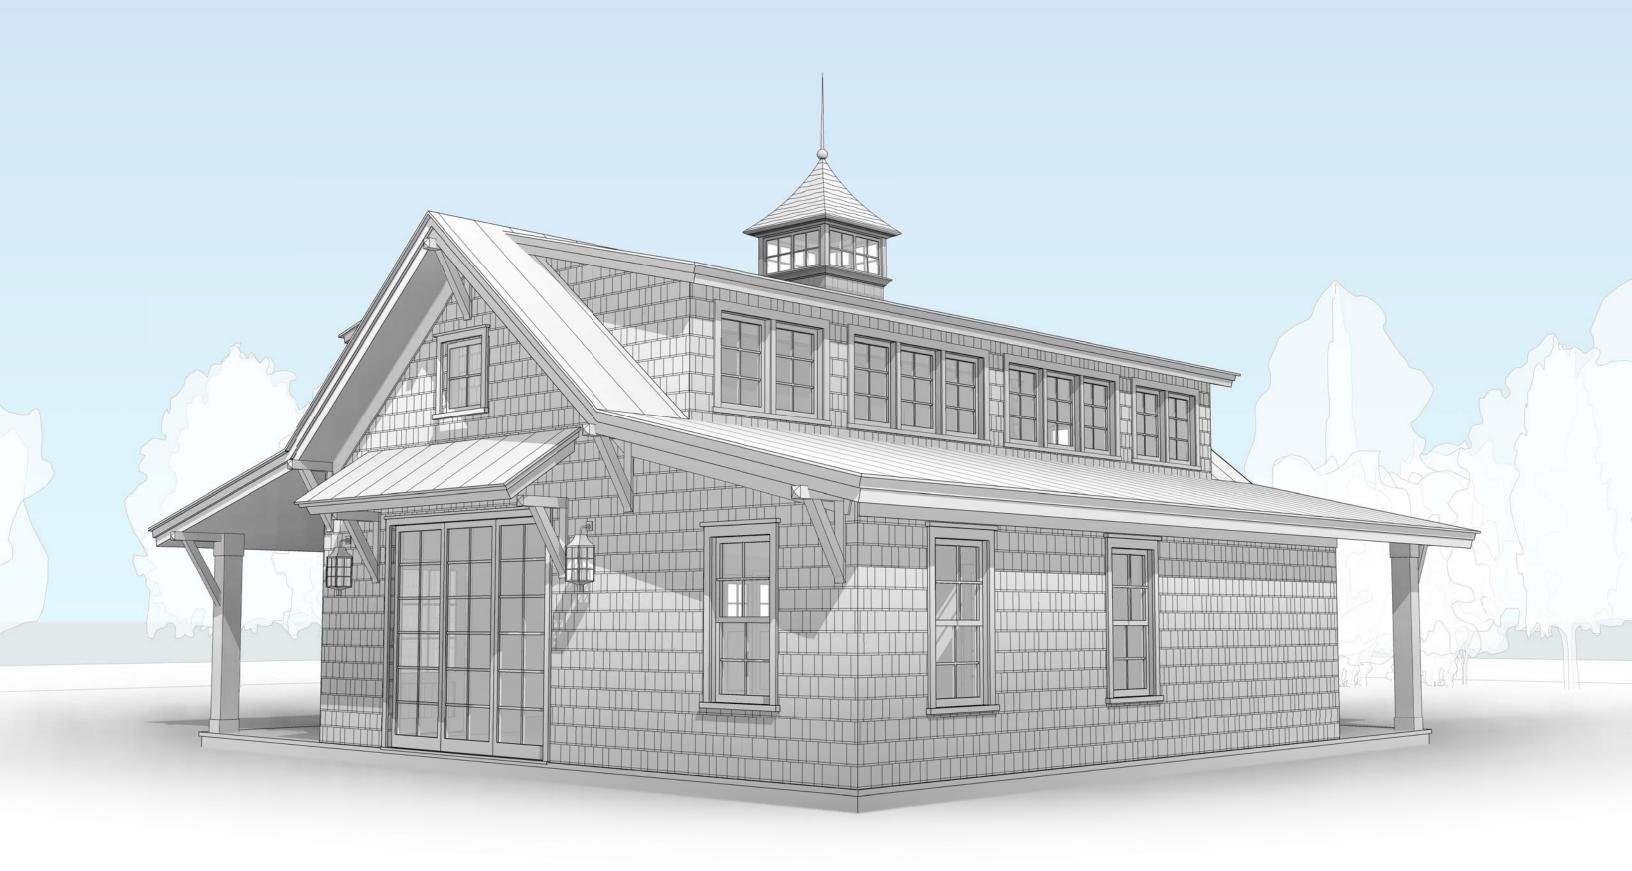

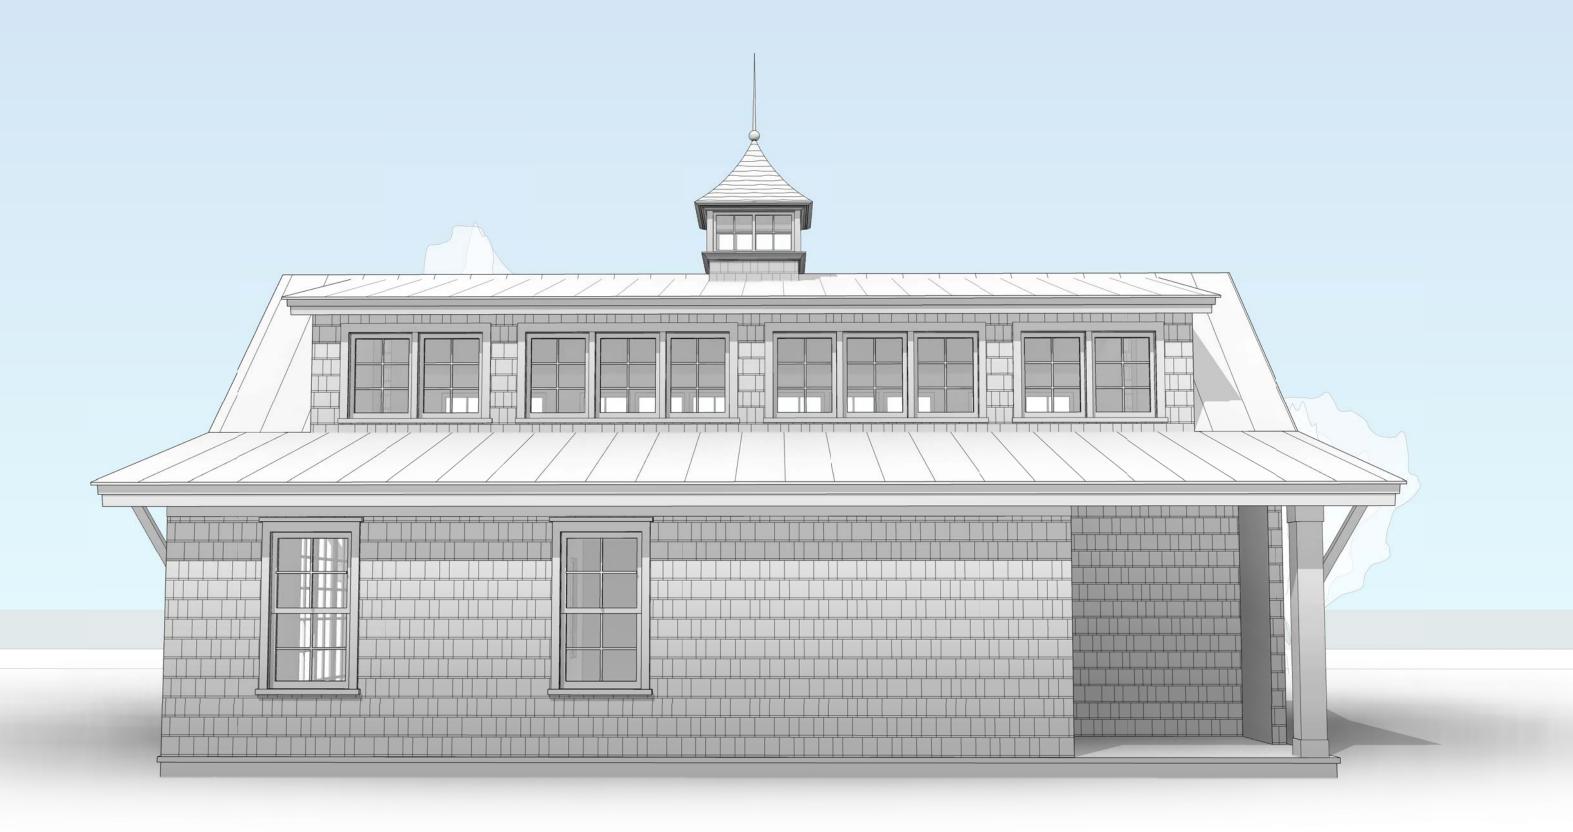

June 22, 2022

Town of Lewisboro Building Department 79 Bouton Street South Salem, NY 10590

Re: The Marschke Residence: New Detached Cabana, Gym & Storage Barn 31 East Ridge Road Waccabuc, New York 10597

LETTER OF AUTHORIZATION

Ladies and Gentlemen,


As owner of the aforementioned property, I give permission to **Darren P. Mercer**, **Architect**, **PLLC**, to act as my agent in matters concerning the construction of an New Detached Cabana, Gym & Storage Barn Project. As my agent, he may act on my behalf in connection with Building Permits, Board Meetings, or other matters concerning this project.

Should you have any questions, please contact my agent at (914) 391- 4490. Thank you for your cooperation in this matter.

Sincerely,

Fine haselite

Rhna Marschke 31 East Ridge Road Waccabuc, New York 10597

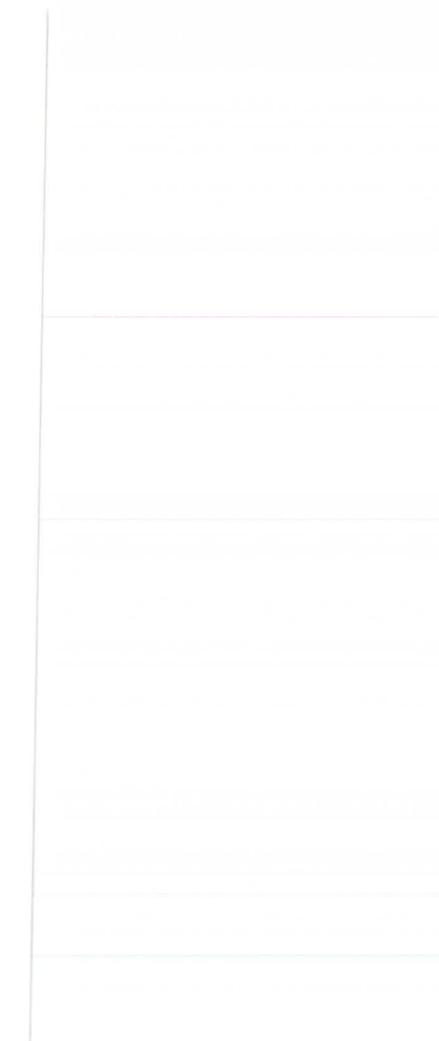

ZONING TABLE

Marschke Residence 31 East Ridge Road Waccabuc, New York

Table of Dimensional Requirements

SHEET 42.2, BLOCK 3, LOT 6

ZONING DISTRICT R-2A (2 ACRE, One Family Residential District)

| MINIMUM LOT SIZE | REQUIRED | EXISTING | PROPOSED |
|--------------------|---------------------|------------------------------|------------------------------|
| Area | 2 Acre 87,120 SF | 3.454 Acres 150,462.473 S | (No Change) F (No Change) |
| MINIMUM YARDS | | | |
| Front Yard | 50 ft | 112.64 ft | (No Change) |
| Left Side | 40 ft | 78.03 ft | (No Change) |
| Right Side | 40 ft | 42.71 ft | (No Change) |
| Rear Yard | 60 ft | 147.77 ft | 358.53' |
| MAXIMUM HEIGHT | | | |
| Stories Feet | 2 ½ 35 ft | 2 30 ft +/- | (No Change) (No Change) |
| MAXIMUM BUILDING | | | |
| Lot Area (percent) | 9% 13,541.62 SF | 3.47% 5.223.12 SF | 4.09% 6,167.12 SF |

| Proposed Cabana, Gym & Storage Barn: | 1,296.0 SF |
|--------------------------------------|------------|
| Existing Shed Building to be Removed | (352.0 SF) |
| Difference | 944.0 SF |



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Zoning Denial 8/23/2022

<u>The Whitman Residence</u> 21C Boutonville Rd South, Cross River 0018-10528-007

The applicant is proposing a detached garage and is requesting a total square footage of 698' whereas 600' is allowed per Article IV Section 220-23E of the Town of Lewisboro Zoning Code.

Building Inspector

Jeff Farrell

Building Department 79 Bouton Road South Salem, New York 10590

ZONING BOARD OF APPEALS

NOTICE OF PUBLIC HEARINGS

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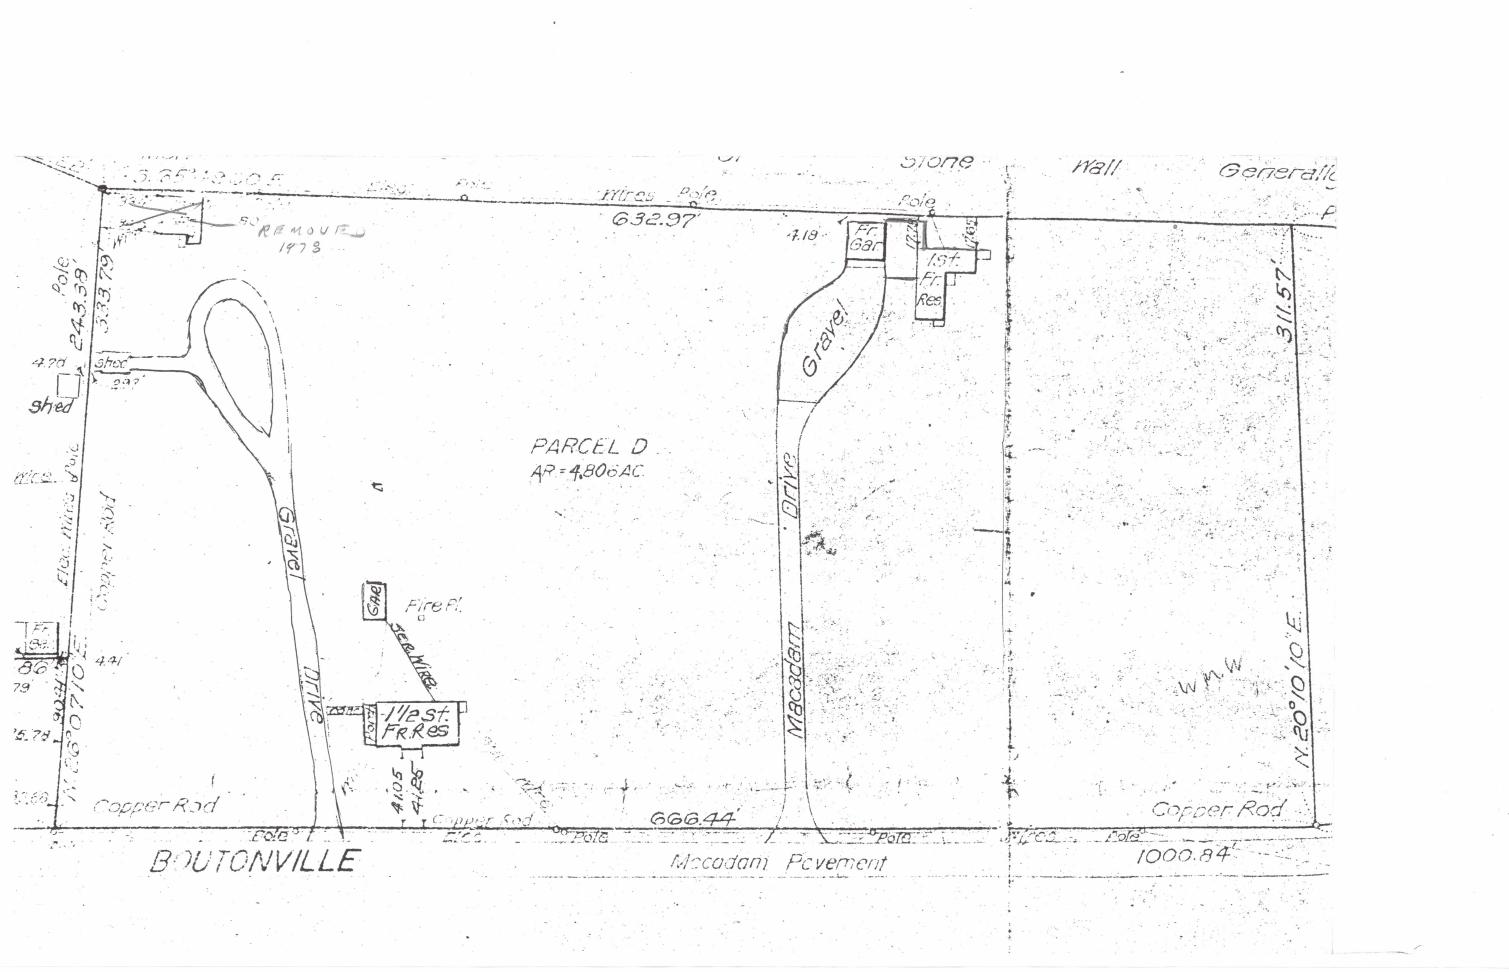
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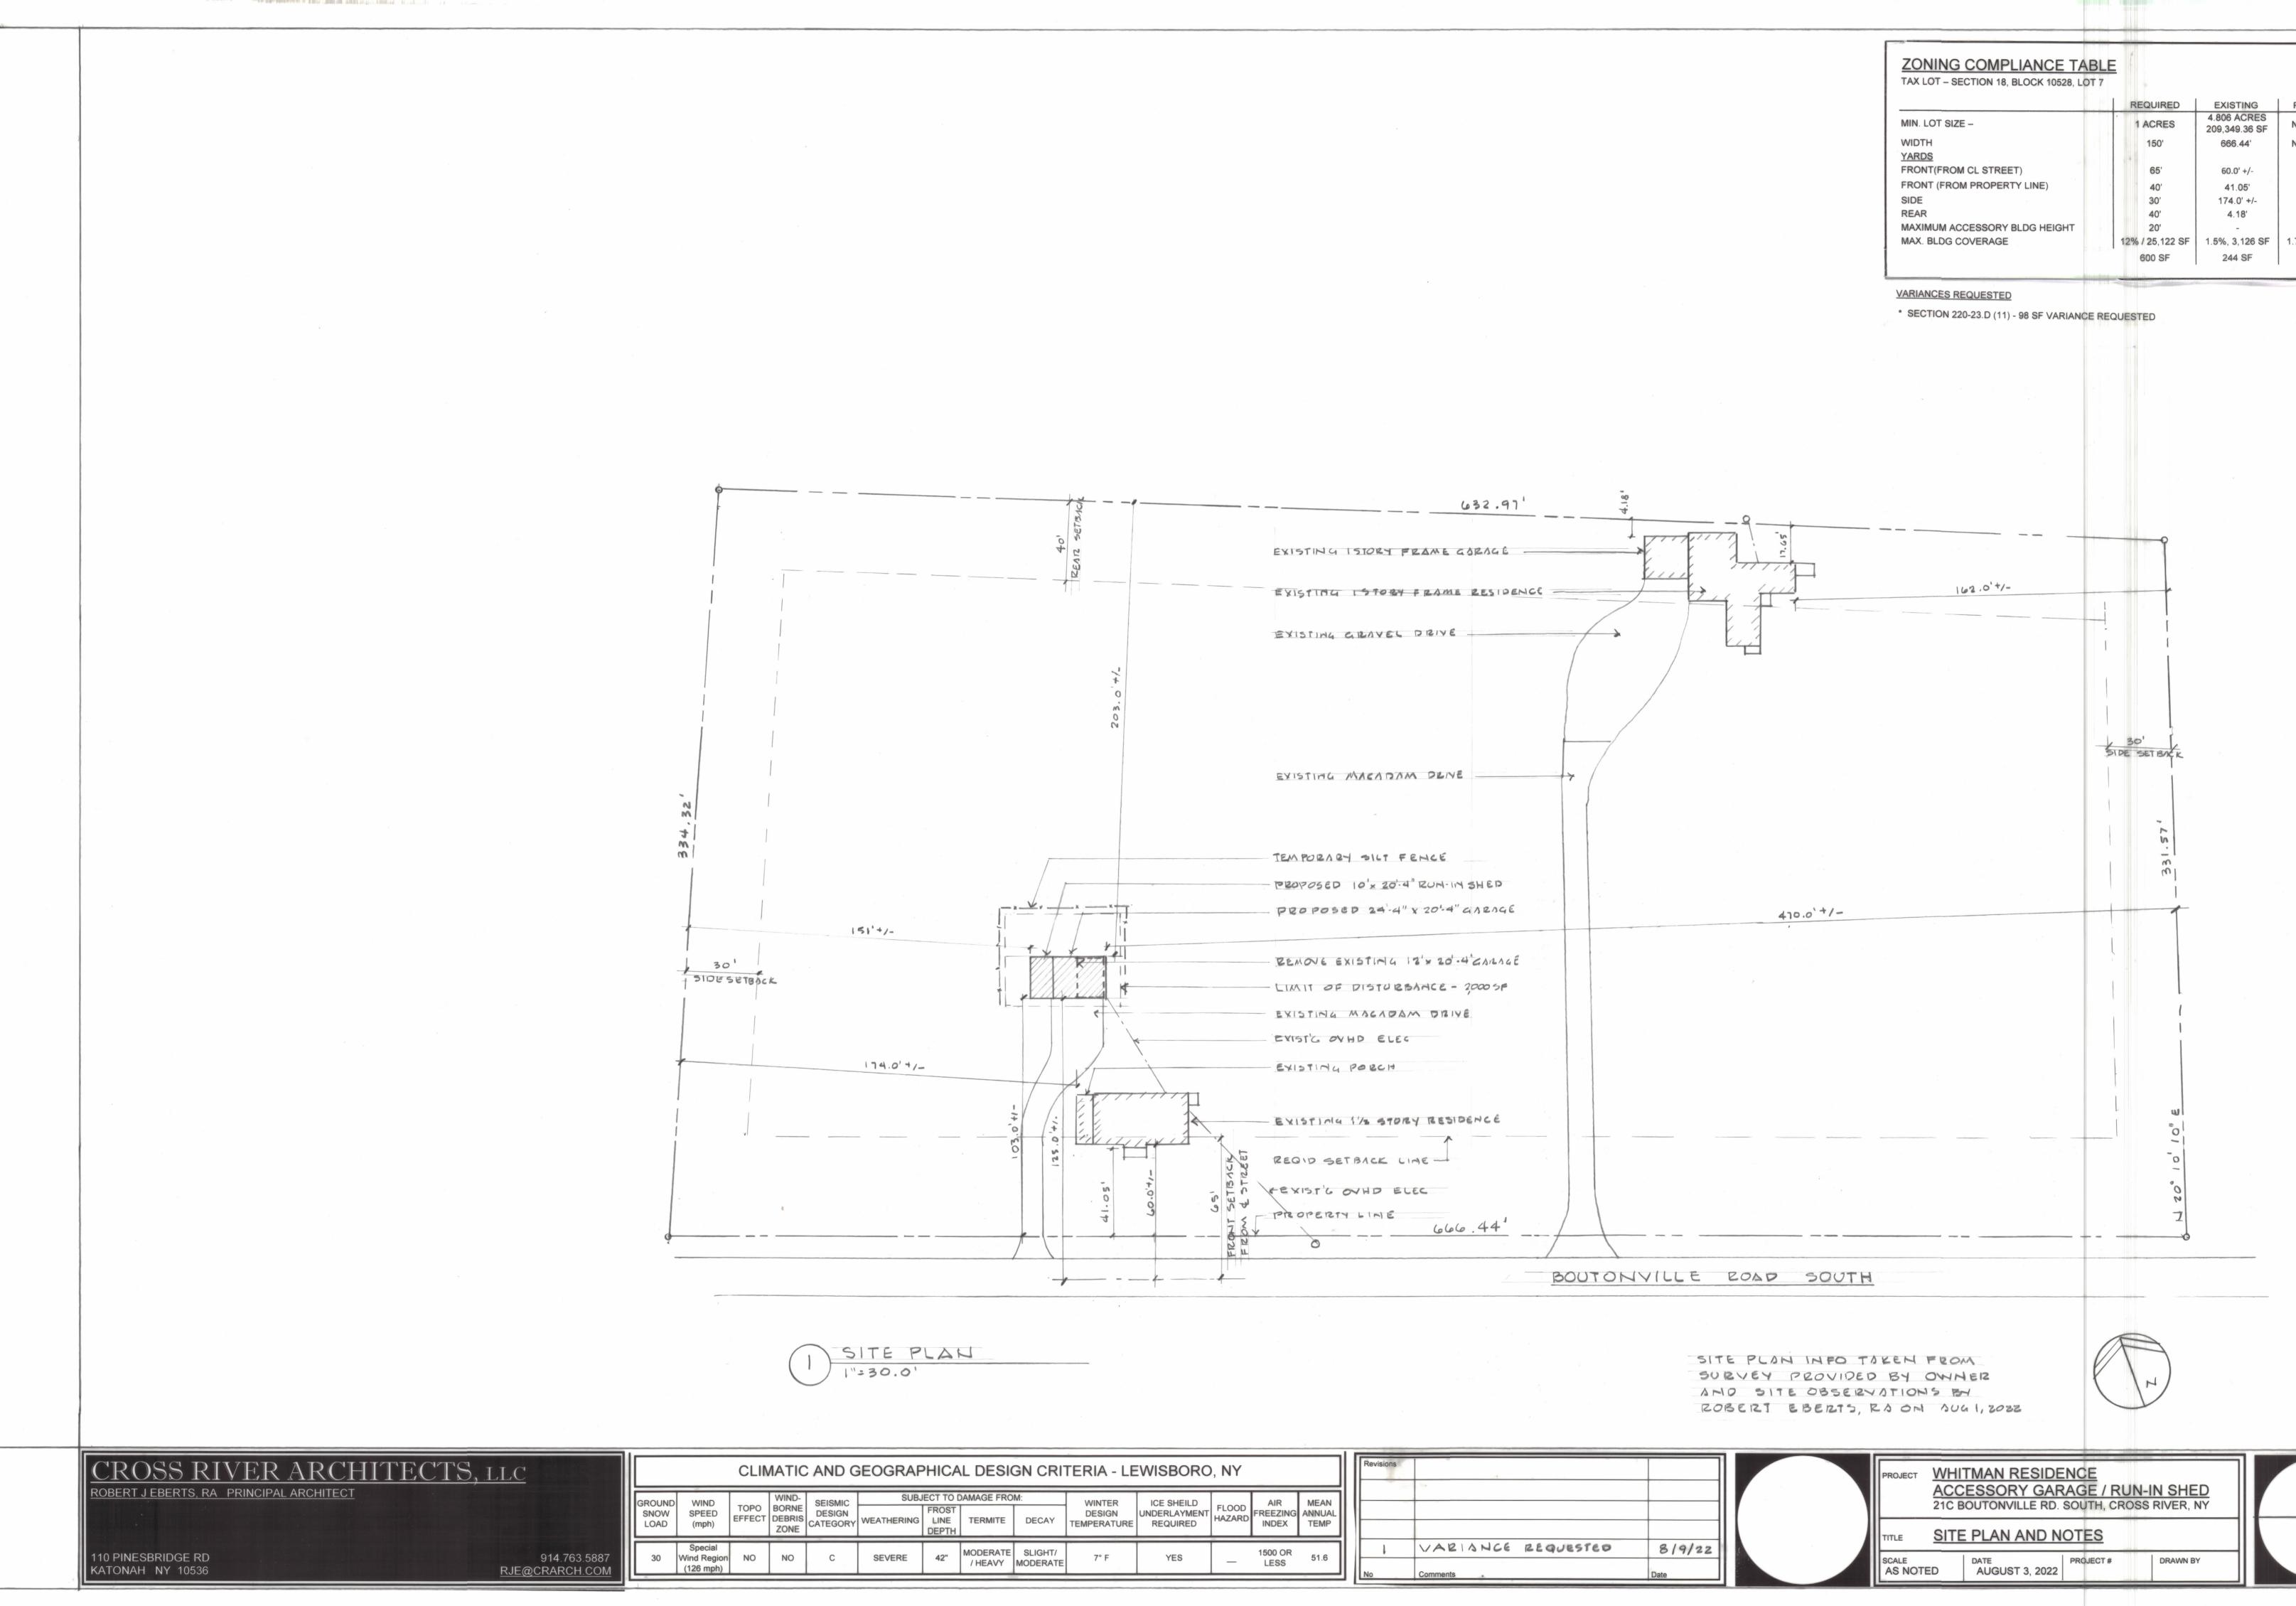
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Additional information regarding this application may be obtained from the Secretary to the Zoning Board of Appeals, 79 Bouton Road, South Salem, New York during regular business hours. At such Hearing, all interested parties may attend and will be heard.

Dated this 31st day of August 2022 in South Salem, New York ZONING BOARD OF APPEALS TOWN OF LEWISBORO By: ROBIN PRICE, JR. CHAIR

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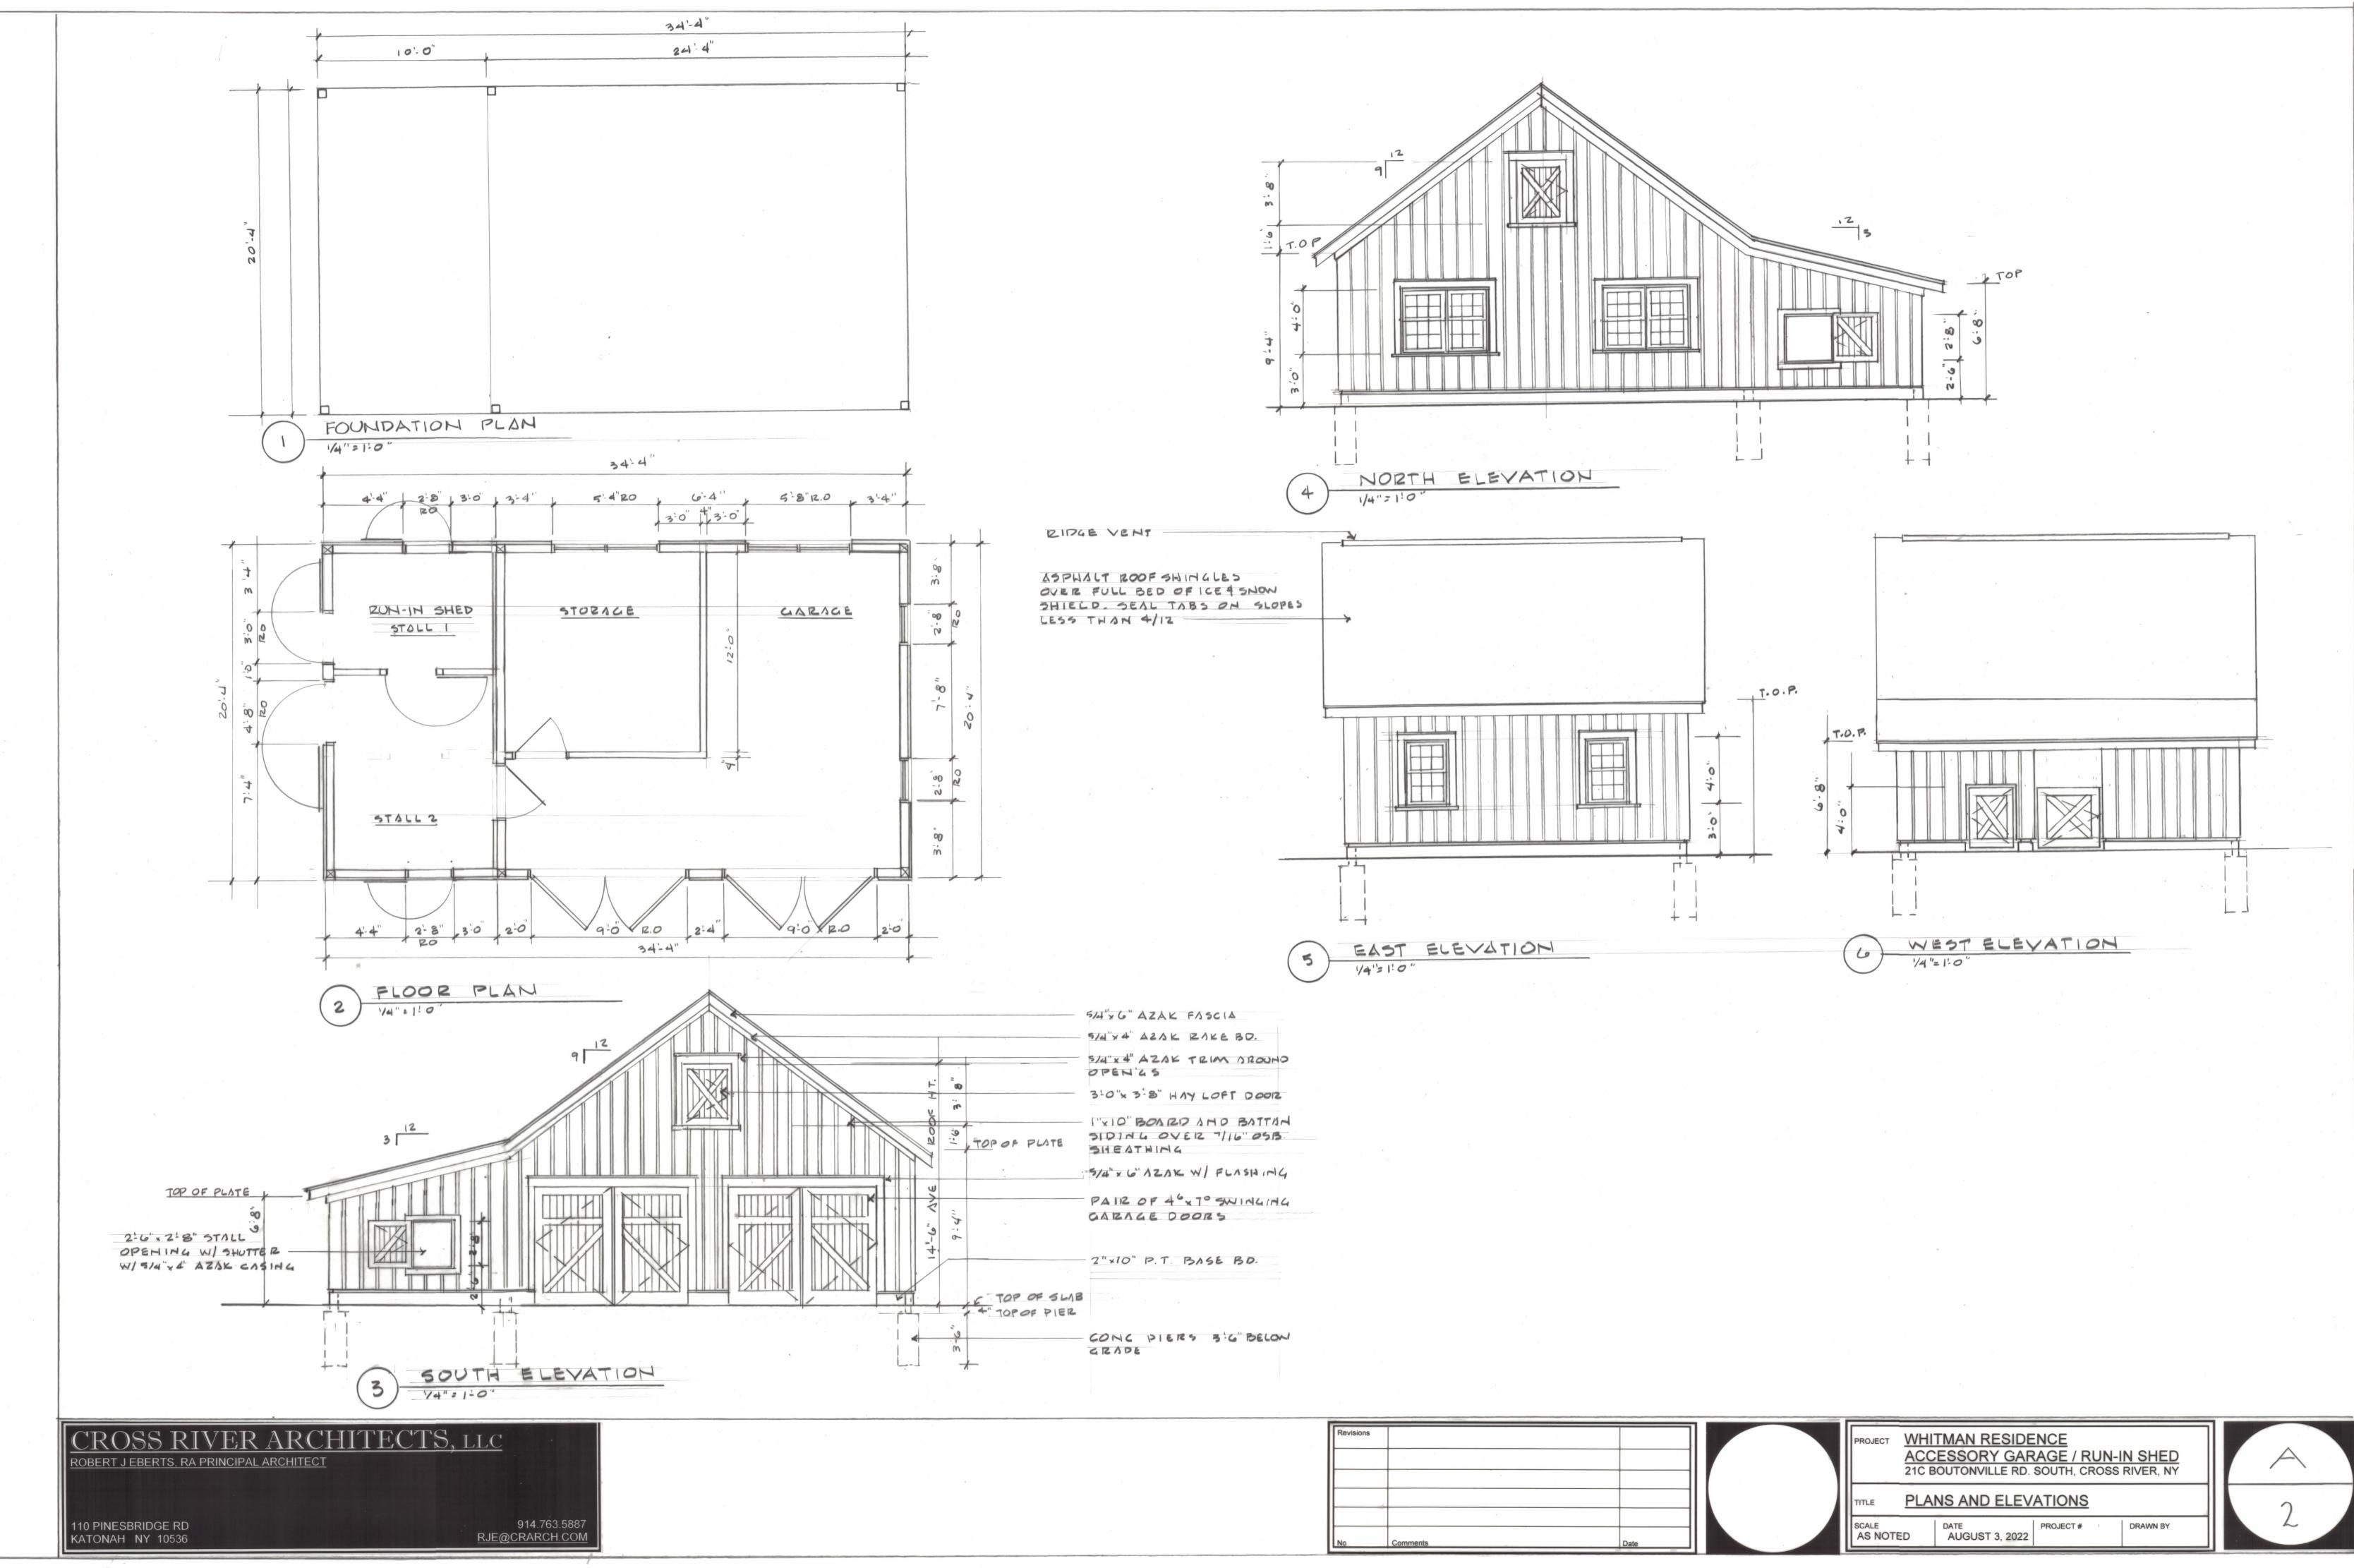




| Revisions | |
|---|------|
| ID GEOGRAPHICAL DESIGN CRITERIA - LEWISBORO, NY | |
| | |
| SMIC SUBJECT TO DAMAGE FROM: WINTER ICE SHEILD FLOOD AIR MEAN | |
| | |
| GORY WEATHERING LINE TERMITE DECAY TEMPERATURE REQUIRED HAZARD INDEX TEMP | |
| | |
| SEVERE 42" MODERATE SLIGHT/ 7°F YES 1500 OR 51.6 | 8/9 |
| SEVERE 42 /HEAVY MODERATE 7 F TES - LESS 51.0 | |
| No Comments | Date |

| | d direct | ALL | | |
|---|-------------|---|------------------------------|----------------|
| ZONING COMPLIANCE TAE TAX LOT - SECTION 18, BLOCK 10528, LOT | | | | ZONE -R1A |
| | | | | |
| | | REQUIRED | EXISTING | PROPOSED |
| MIN. LOT SIZE - | | 1 ACRES | 4.806 ACRES 209,349.36 SF | NO CHANGE |
| WIDTH | | 150' | 666.44 | NO CHANGE |
| YARDS | | | | |
| FRONT(FROM CL STREET) | | 65' | 60.0' +/- | 125'+/- |
| FRONT (FROM PROPERTY LINE) | | 40' | 41.05 | 103.0' +/-' |
| SIDE | | 30' | 174.0' +/- | 151' +/- |
| REAR | | 40' | 4.18' | 203' +/- |
| MAXIMUM ACCESSORY BLDG HEIGHT | | 20' | · - | 15' |
| MAX. BLDG COVERAGE | | 12% / 25,122 SF | 1.5%, 3,126 SF | 1.7%, 3,573 SF |
| | | 600 SF | 244 SF | 798 SF * |
| | in this way | | | |

A



| Revisions | |
|------------------|--|
| | PROJECT WHITMAN RESIDENCE ACCESSORY GARAGE / RUN-IN SHED 21C BOUTONVILLE RD. SOUTH, CROSS RIVER, NY |
| | TITLE PLANS AND ELEVATIONS |
| No Comments Date | SCALE DATE PROJECT # DRAWN BY AS NOTED AUGUST 3, 2022 PROJECT # DRAWN BY |



Tel: (914) 763-3060 Fax: (914) 875-9148 Email: jfarrell@lewisborogov.com

Zoning Denial 8/24/2022

<u>The Hadar Residence</u> 20 Manor Dr. Goldens Bridge 0007-11137-166

The applicant is proposing a detached studio and is requesting a total square footage of 2412' whereas 600' is allowed per Article IV Section 220-23E of the Town of Lewisboro Zoning Code.

The applicant is proposing a detached studio home occupation space and is requesting a total square footage of 2412' whereas 500' is allowed per Article IV Section 220-23D-1-C of the Town of Lewisboro Zoning Code.

Building Inspector

Jeff Farrell

Building Department 79 Bouton Road South Salem, New York 10590

ZONING BOARD OF APPEALS

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CAL. NO. 26-22-BZ


Application of Joshua Hadar [The Joshua D. Hadar Family Trust, owner of record], 20 Manor Drive, Goldens Bridge, NY for the following variance of the proposed detached studio and is requesting a total square footage of 2412' whereas 600' is allowed per Article IV Section 220-23E of the Town of Lewisboro Zoning Code, the applicant is proposing a detached studio home occupation space and is requesting a total square footage of 2412' whereas 500' is allowed per Article IV Section 220-23E.

The property is located on the north side of (#20) Manor Drive, Goldens Bridge, NY designated on the Tax Map as Sheet 0007 Block 11137 Lot 166 & 165, in a 2-AC, Two-Acre Residential District, consisting of approximately 13.21 acres.


Additional information regarding this application may be obtained from the Secretary to the Zoning Board of Appeals, 79 Bouton Road, South Salem, New York during regular business hours. At such Hearing, all interested parties may attend and will be heard.

Dated this 31st day of August 2022 in South Salem, New York ZONING BOARD OF APPEALS TOWN OF LEWISBORO By: ROBIN PRICE CHAIR

The Town of Lewisboro is committed to equal access for all citizens. Anyone needing accommodations to attend or participate in this meeting is encouraged to notify the Secretary to the Zoning Board of Appeals in advance.

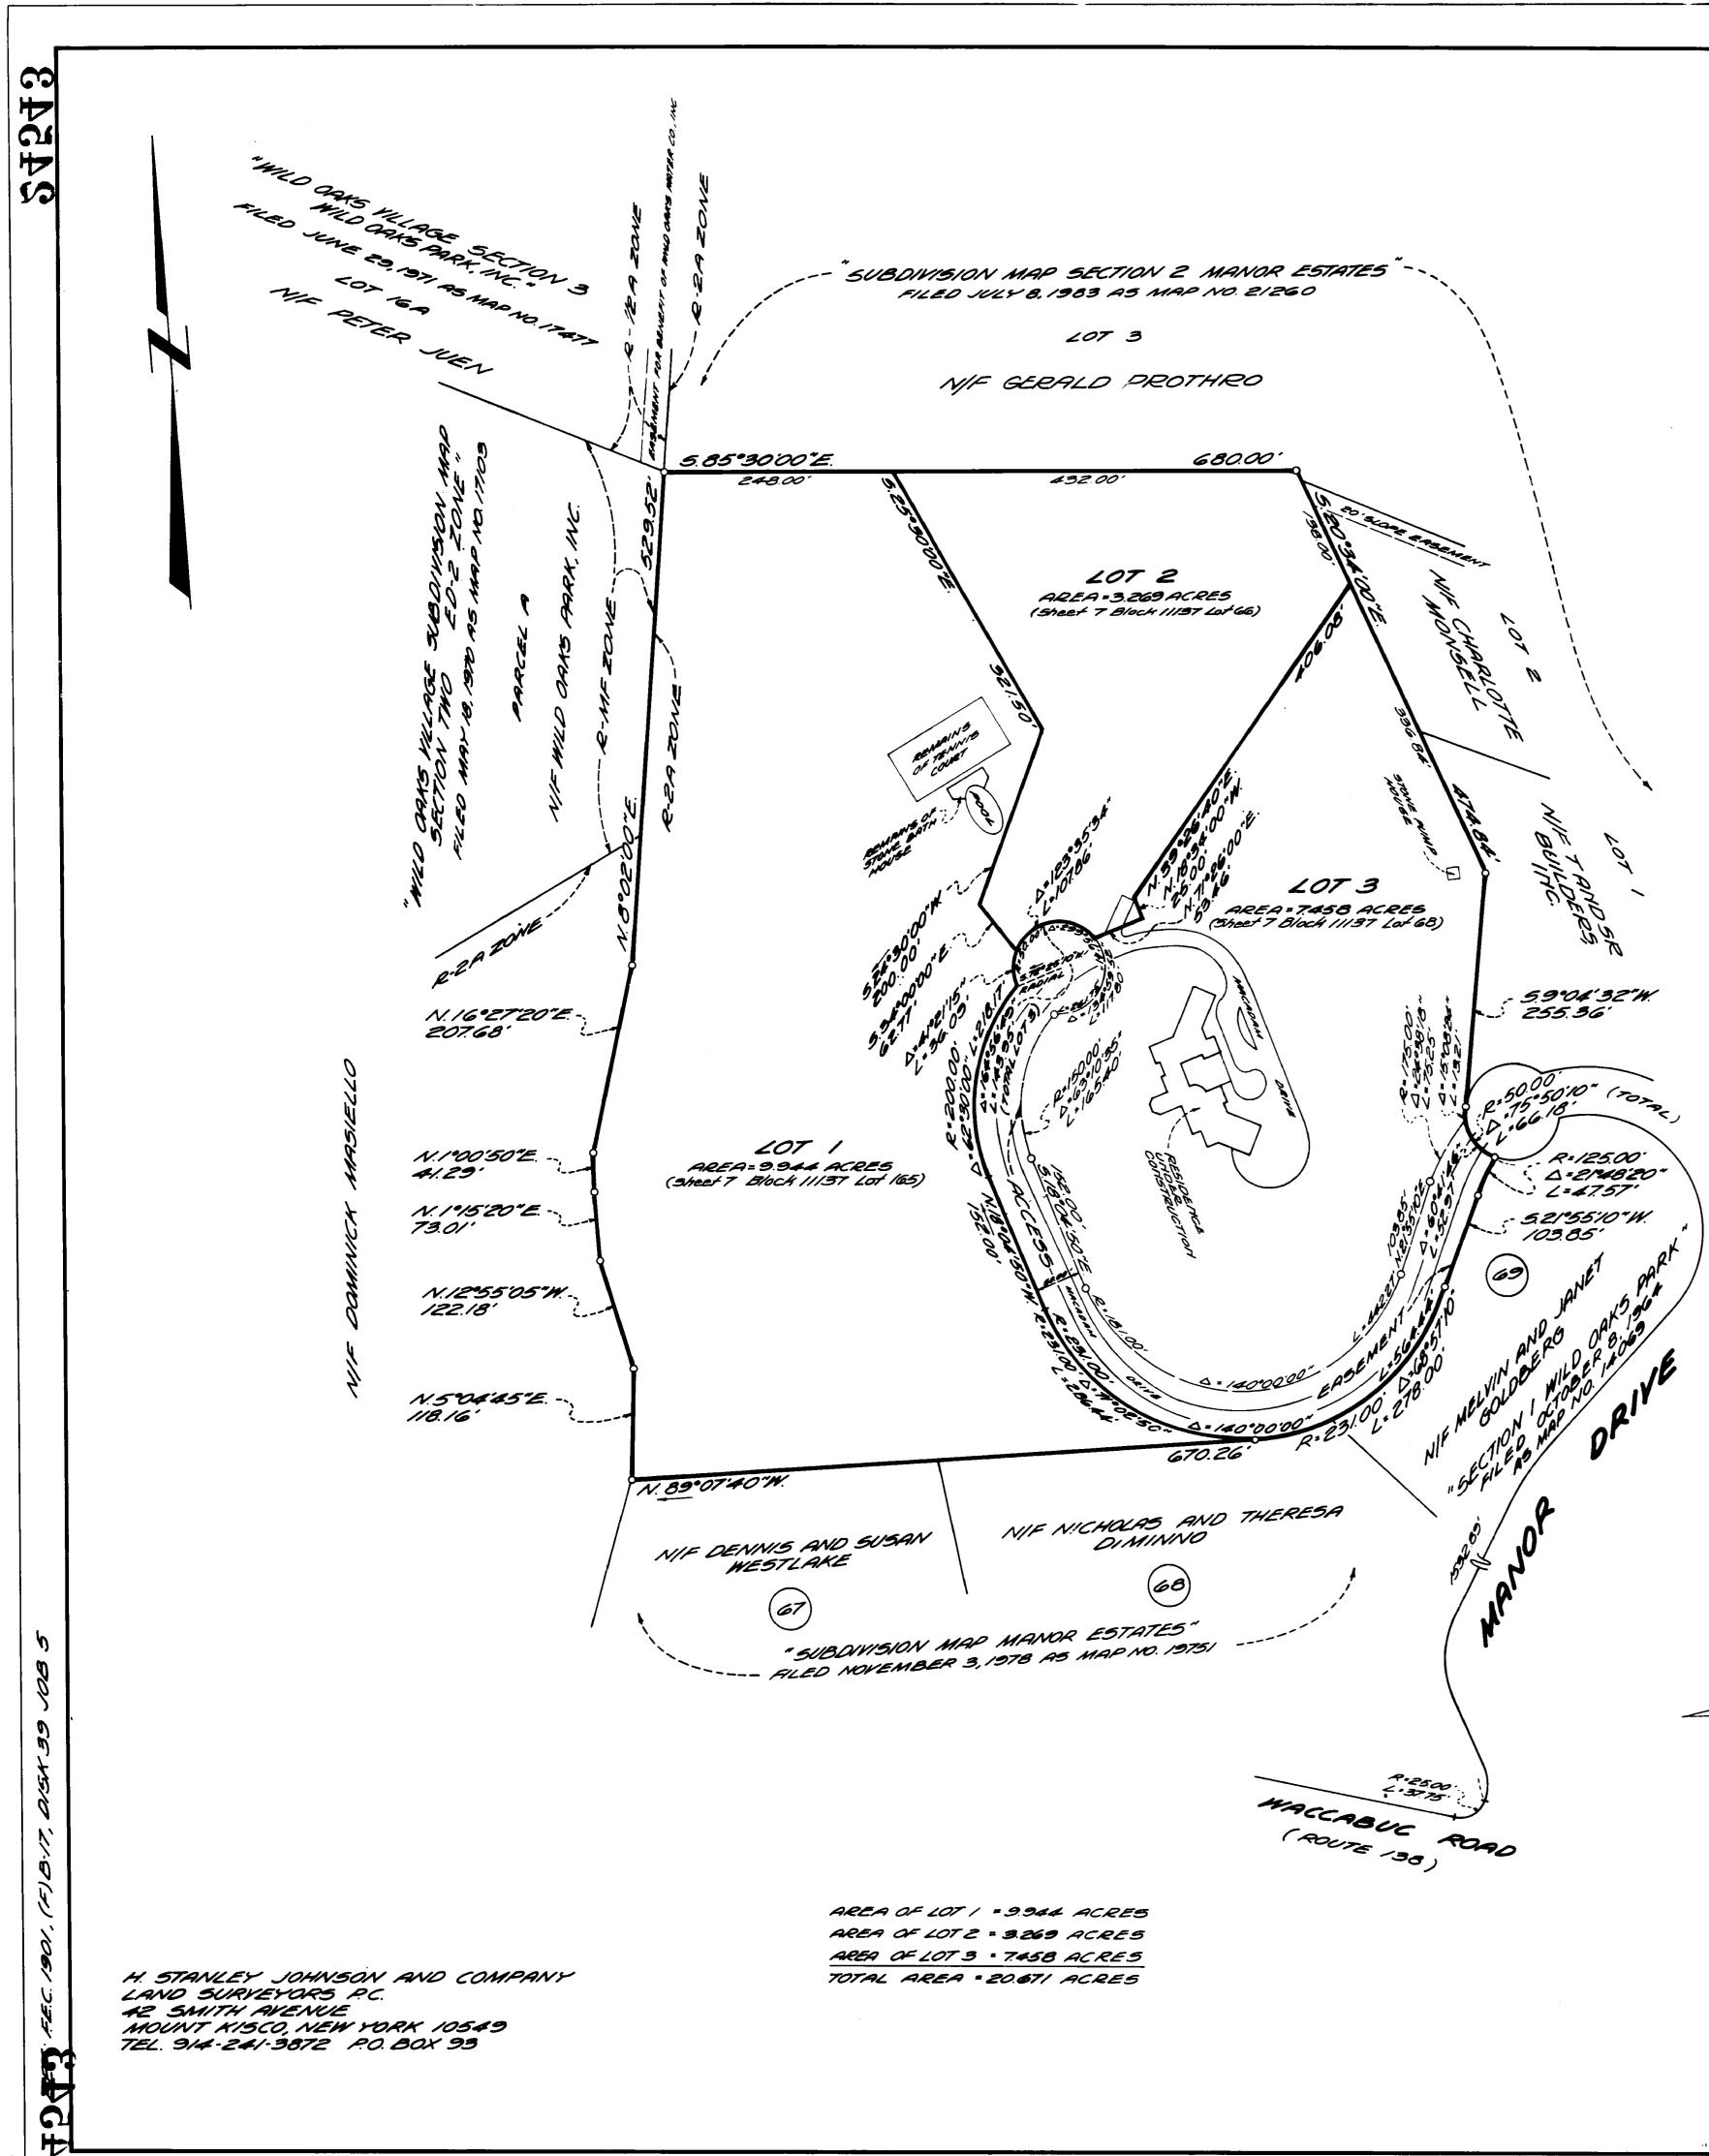

V.

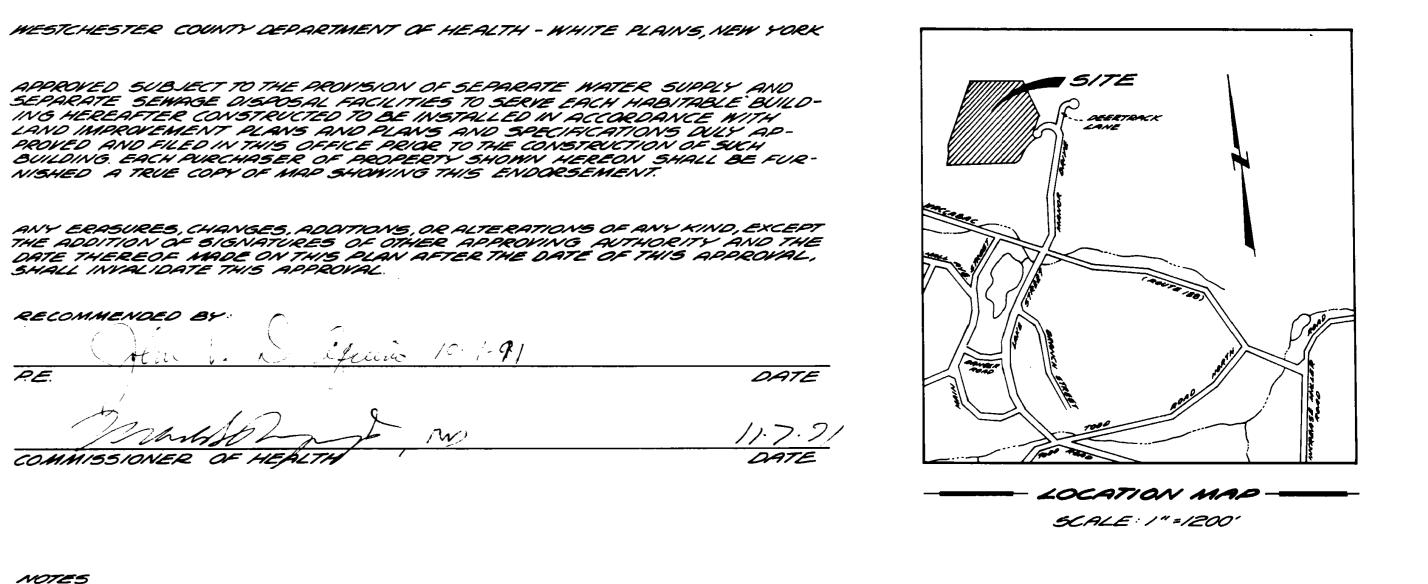

NOTES

- I. PREMISES SMOWN HEREON LOCATED IN THE R-2A (ONE-FAMILY RESIDENCE)ZONE IN THE TOWN OF LEWISBORD.
- 2. PREMISES SHOWN HEREON KNOWN AND DESIGNATED AS SHEET T. BLOCK 11137, LOTS 66, 68 AND 165.
- 3. THE COMPLETION OF CONSTRUCTION OF THE COMMON DRIVE SHOWN ON THIS PLAT IS COVERED BY A RESTRICTION AS FILED IN THE OFFICE OF THE CLERK OF THE COUNTY OF WESTCHESTER, DIVISION OF LAND RECORDS, LIBER TO OF MISC., AT PAGE 183, AND ENTITLED "COMMON DRIVEWAY SPECIFICATIONS FOR FALCON ROCH SUBDIVISION IN THE TOWN OF LEWISBORD." HOWEVER THIS SPECIFICATION IS NOLONGER IN FORCE, EXCEPT FOR PARAGRAPHS I AND G. THE CONSTRUCTION OF THE COMMON DRIVE, IN CONJUNCTION WITH MOTES I AND G, SHALL BE GOVERNED BY THE DRAWING ENTITLED "PROPOSED AMENDINENT TO COMMON DRIVEWAY PLAN, FALCON ROCH SUBDIVISION, TOWN OF LEWISBORO, "SHEET I OF I AS PREPARED BY JAMES J. HAHN ENGINEERING, DATED MAY 28,1991 AND LAST REVISED SEPTEMBER 26,1991. NOCERTIFICATE OF OCCUPANCY SHALL BE ISSUED UNTIL THE PROVE, INCLUDING OLL DRAINAGE AND RETENTION STRUCTURES, IS COMPLETE.
- 5. THE FINAL PAVENTENT COURSE OF THE COMMON DRIVEWAY SHALL BE INSTALLED AFTER COMPLETION OF CONSTRUCTION OF THE RESIDENCES ON LOTS 2 AND 3, AND PRIOR TO THE
- G. THERE SHALL BE NO FURTHER SUBDIVISION OF LOTS 1, 2 OR 3 INTO ADDITIONAL LOTS.

ISSURNCE OF ANY CERTIFICATES OF OCCUPANCH

That VP NEW YORK STATE LICENSED PROFESSIONAL ENGINEER NO. 54782 DANIEL COPPELMAN, P.E. NEANE COPPELMAN ENGINEERS, P.C. 113 SMITH AVENUE MOUNT KISCO, NEW YORK, 10549

REVISED: NOVEMBER 5,1391 REVISED: OCTOBER 15,1991

THIS MAP, DO HEREBY CERTIFY THAT THE SURVEY UPON WHICH THIS MAP IS BASED WAS COMPLETED: MARCH 13, 1987 AND THAT THIS MAP WAS COMPLETED. JULY 31, 1991.

BER BAND SURVEYOR NO. 38804 NEW YORK STATE LKE

4. THE COMMON DRIVEWAY IS NEVER TO BE DEDICATED AS A TOWN ROAD.

PREMISES SHOWN HEREON BEING LOCATED ON SHEETS 267 AND 268 BLOCK 11137 IN THE WEST-CHESTER COUNTY BLOCK INDEX MAPS.

PROPERTY SHOWN HEREON IS SUBJECT TO "RULES AND REGULATIONS " FOR THE PROTECTION FROM CONTAMINATION OF THE NEW YORK CITY WATER SUPPLY AND IT'S SOURCES. OFFICES OF THE CITY OF NEW YORK DEPARTMENT OF WATER RESOURCES FOR CROTON WATERSHED, ROUTE 35, KATONAH, NEW YORK.

APPROVED BY RESOLUTION OF THE LEWISBORD TOWN PLANNING BOARD.

12010 CHAIRMAN DATE /20/9/ DATE

APPROVED FOR FILING IN THE WESTCHESTER COUNTY CLERKS OFFICE, DIVISION OF LAND RECORDS.

1 11 AMA Milalaherger 4 NAV 91 DATE OWNER SHEAR HIL RD. BOX 13074, MAHOPAC, NI.Y. 1054 ADDRESS

6 NOV OWNER

P. G. Box 529 SOMERS NY. 10589

| FILED | DEC 17 1991 24543 |
|----------|----------------------|
| FEE PAIL | 10- |

Flied in the Office of the County Clerk of Wesichesian County (Division of Land Records)

December 17, 1991 Indrew 1 Jpanom

AMENDED SUBDIVISION KNOWN AS


FALCON ROCK


SITUATE IN THE


TOWN OF LEWISBORD WESTCHESTER COUNTY, NEW YORK THIS SUBDIVISION MAP AMENDS FILED MAP NO. 23346.


SCALE : 1" = 100'



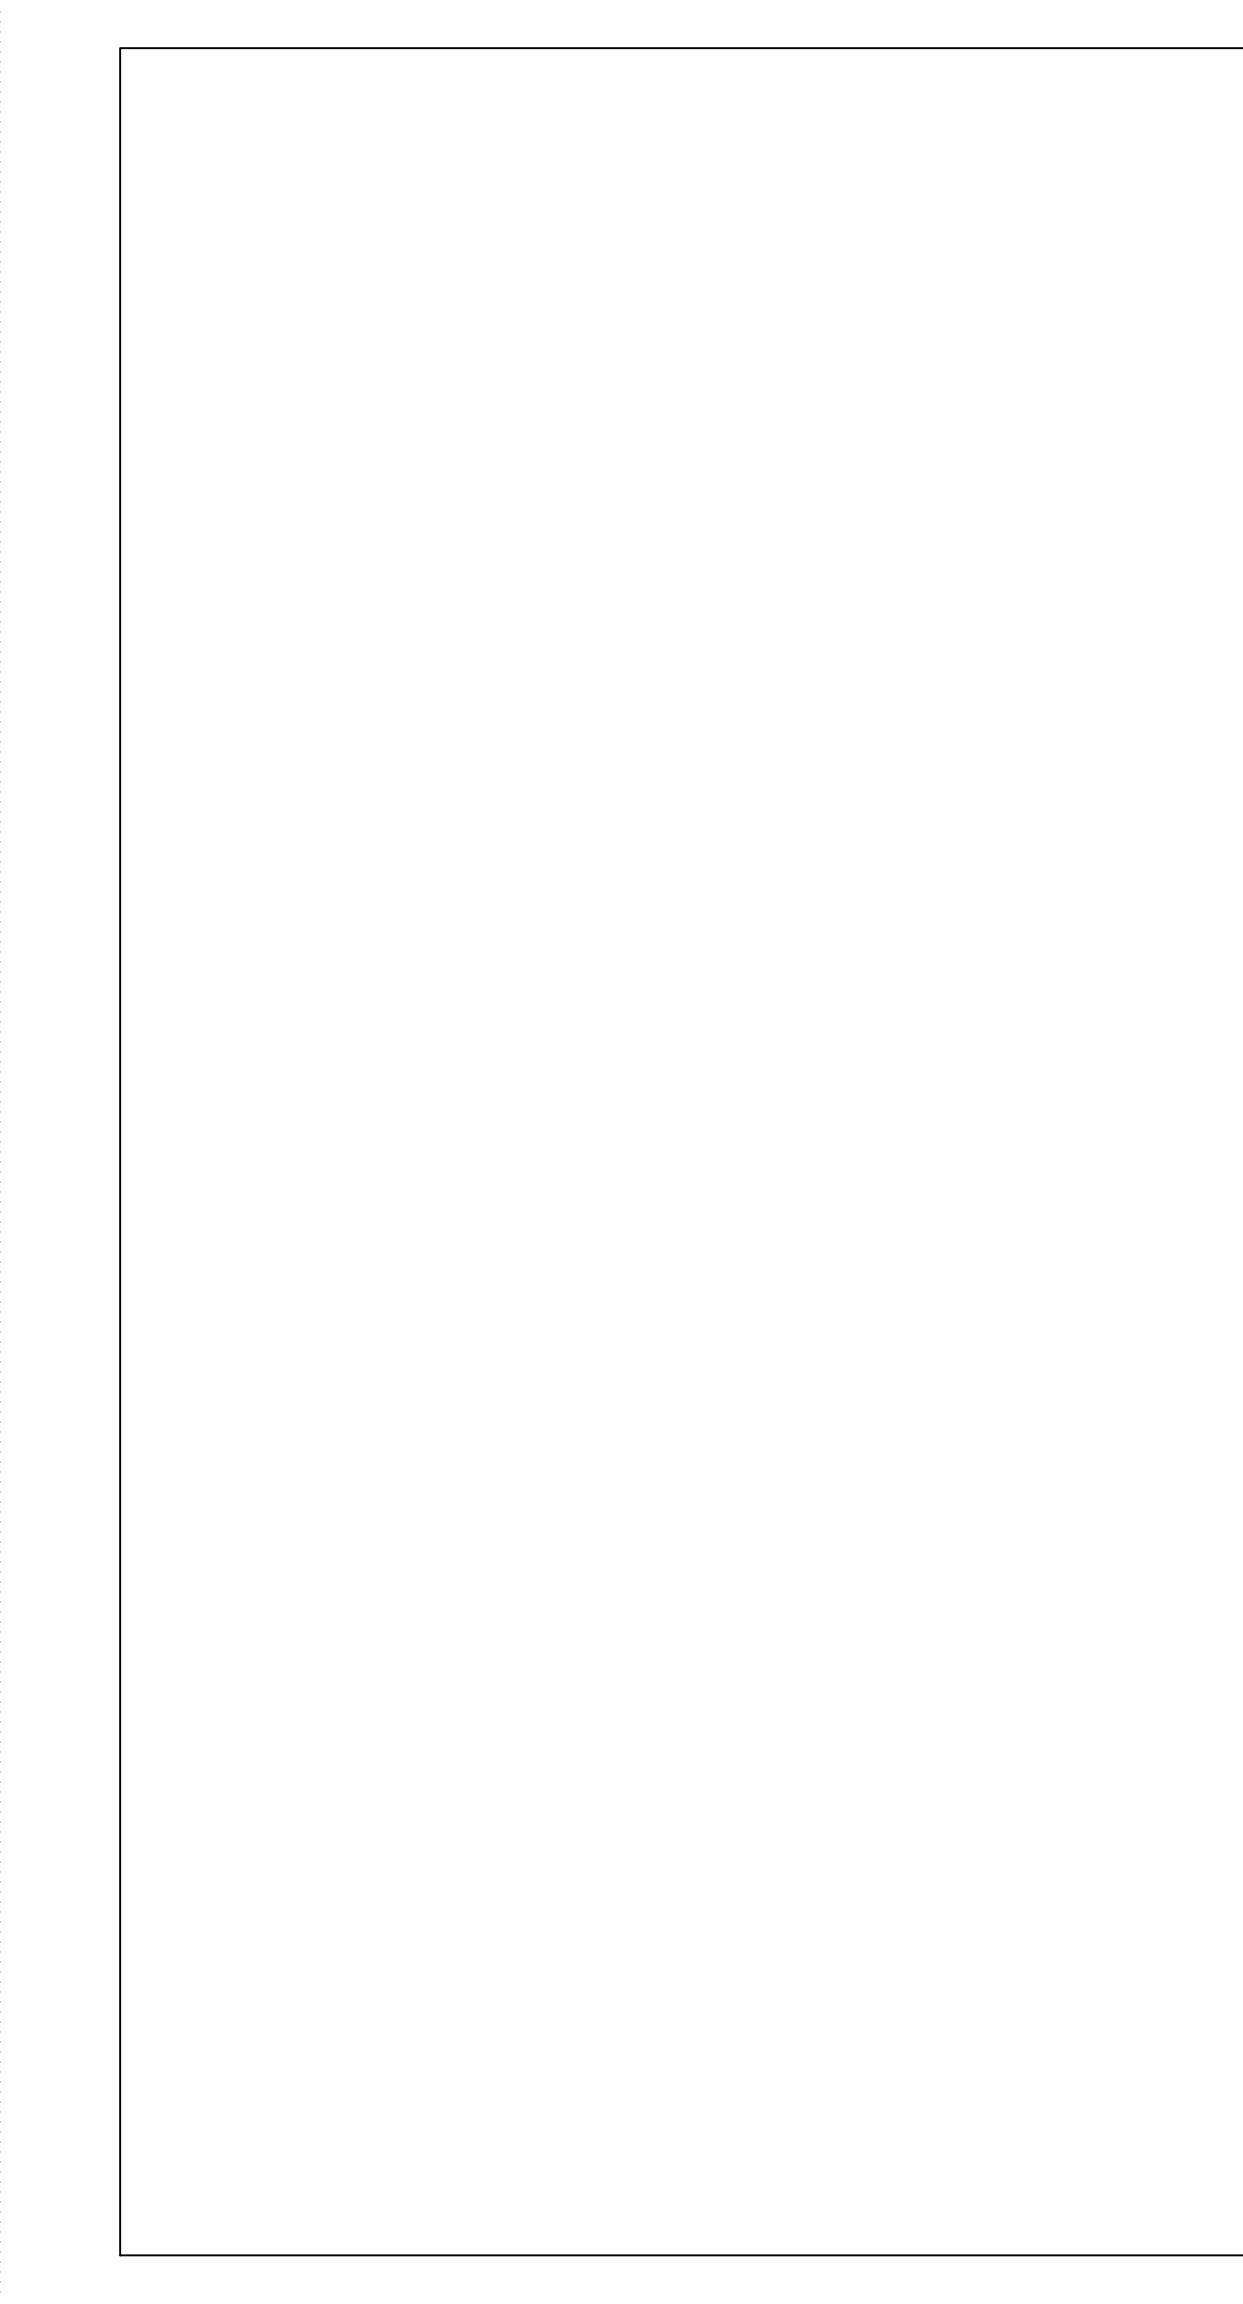


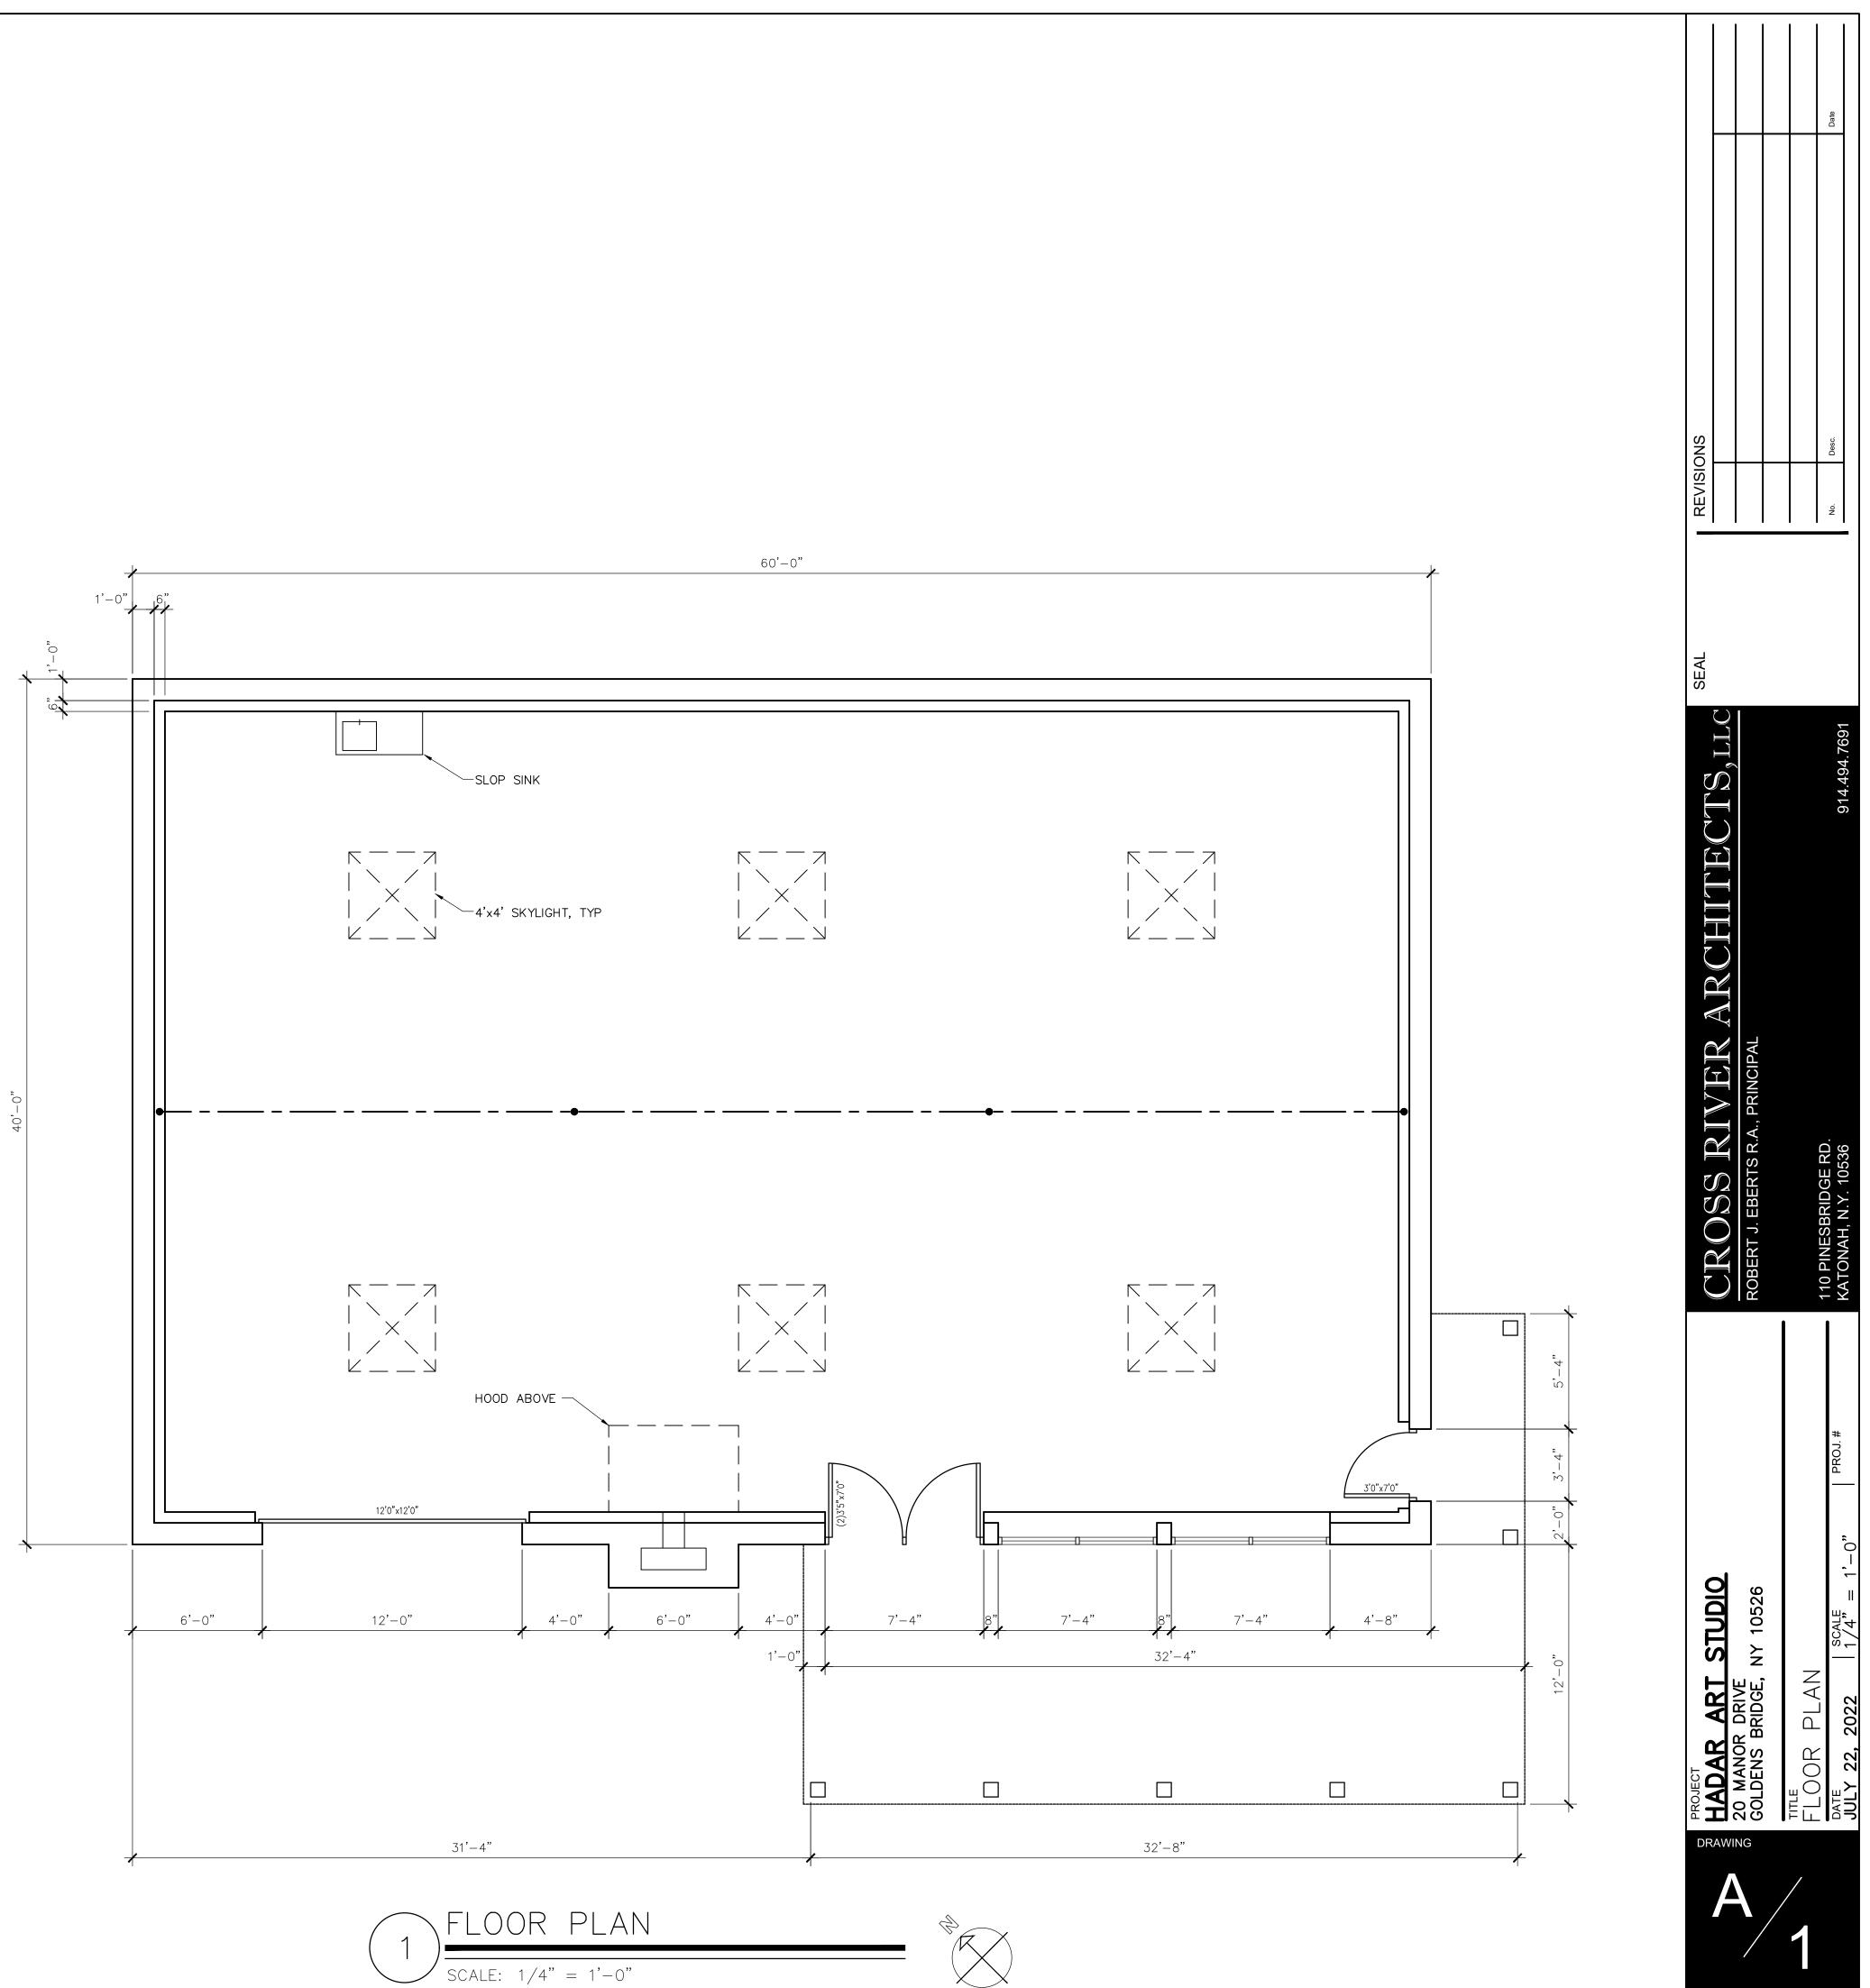


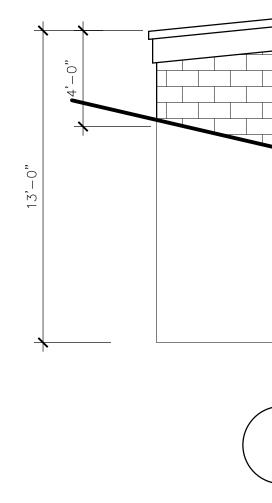


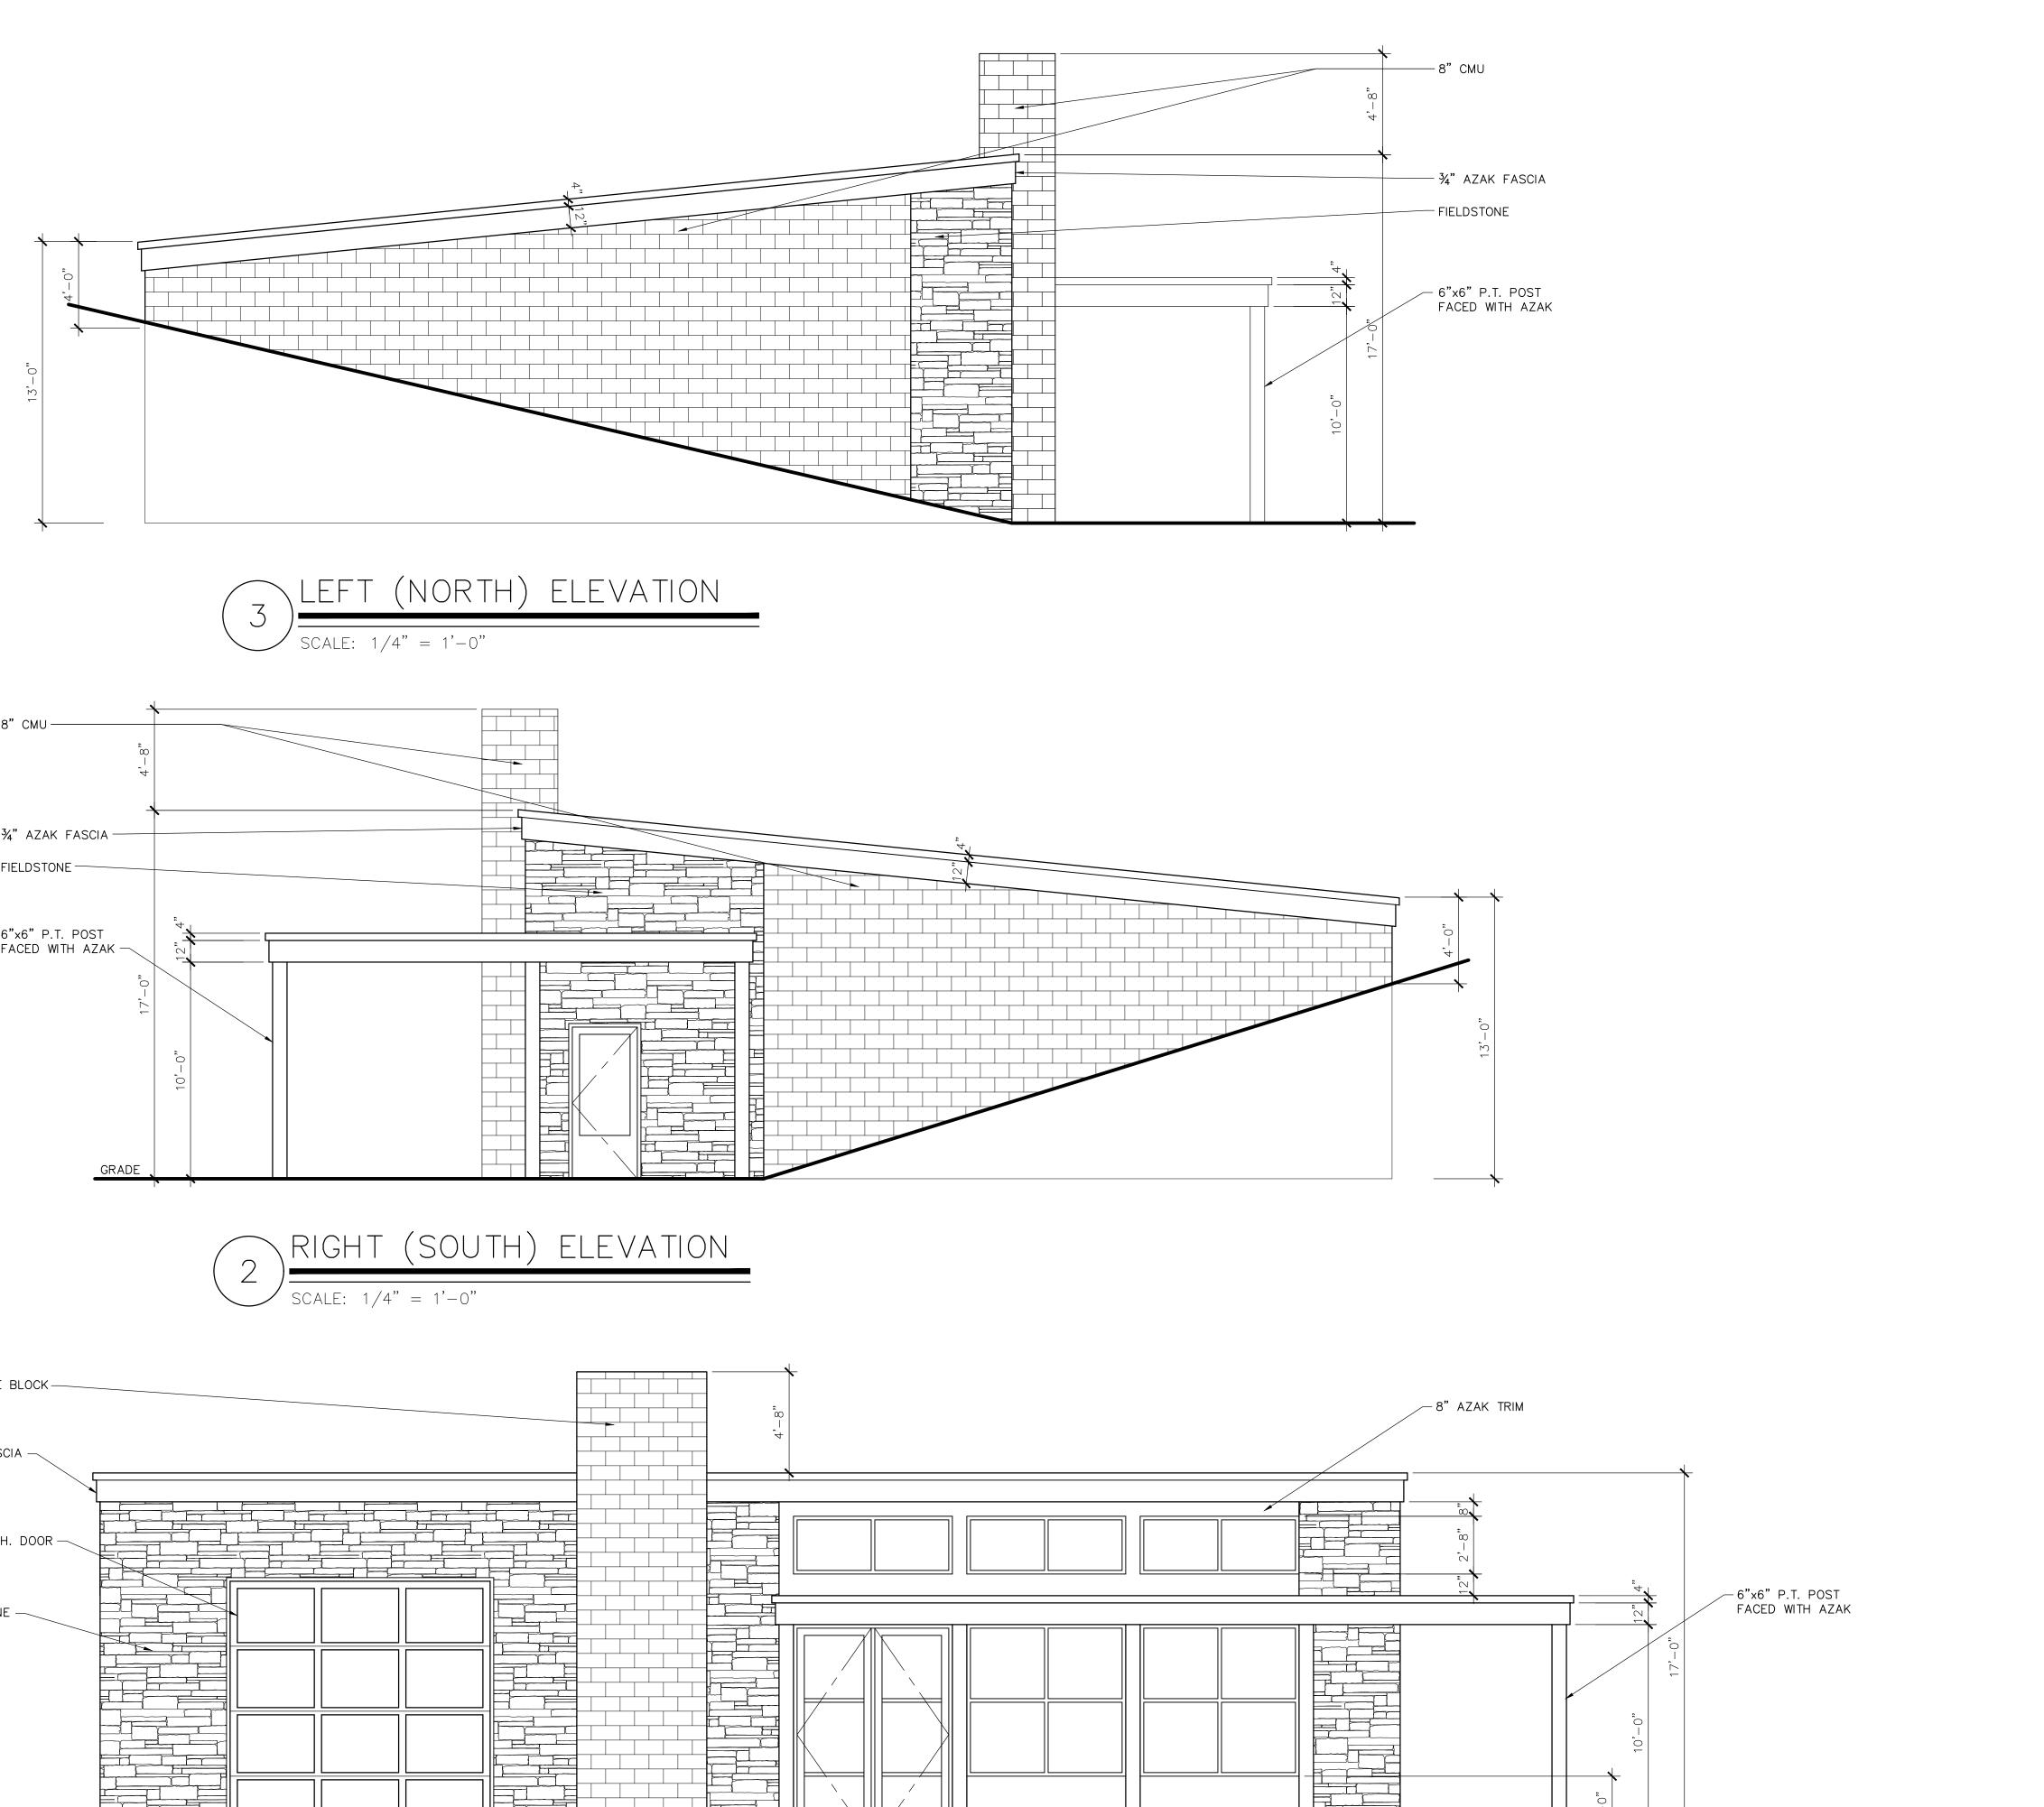




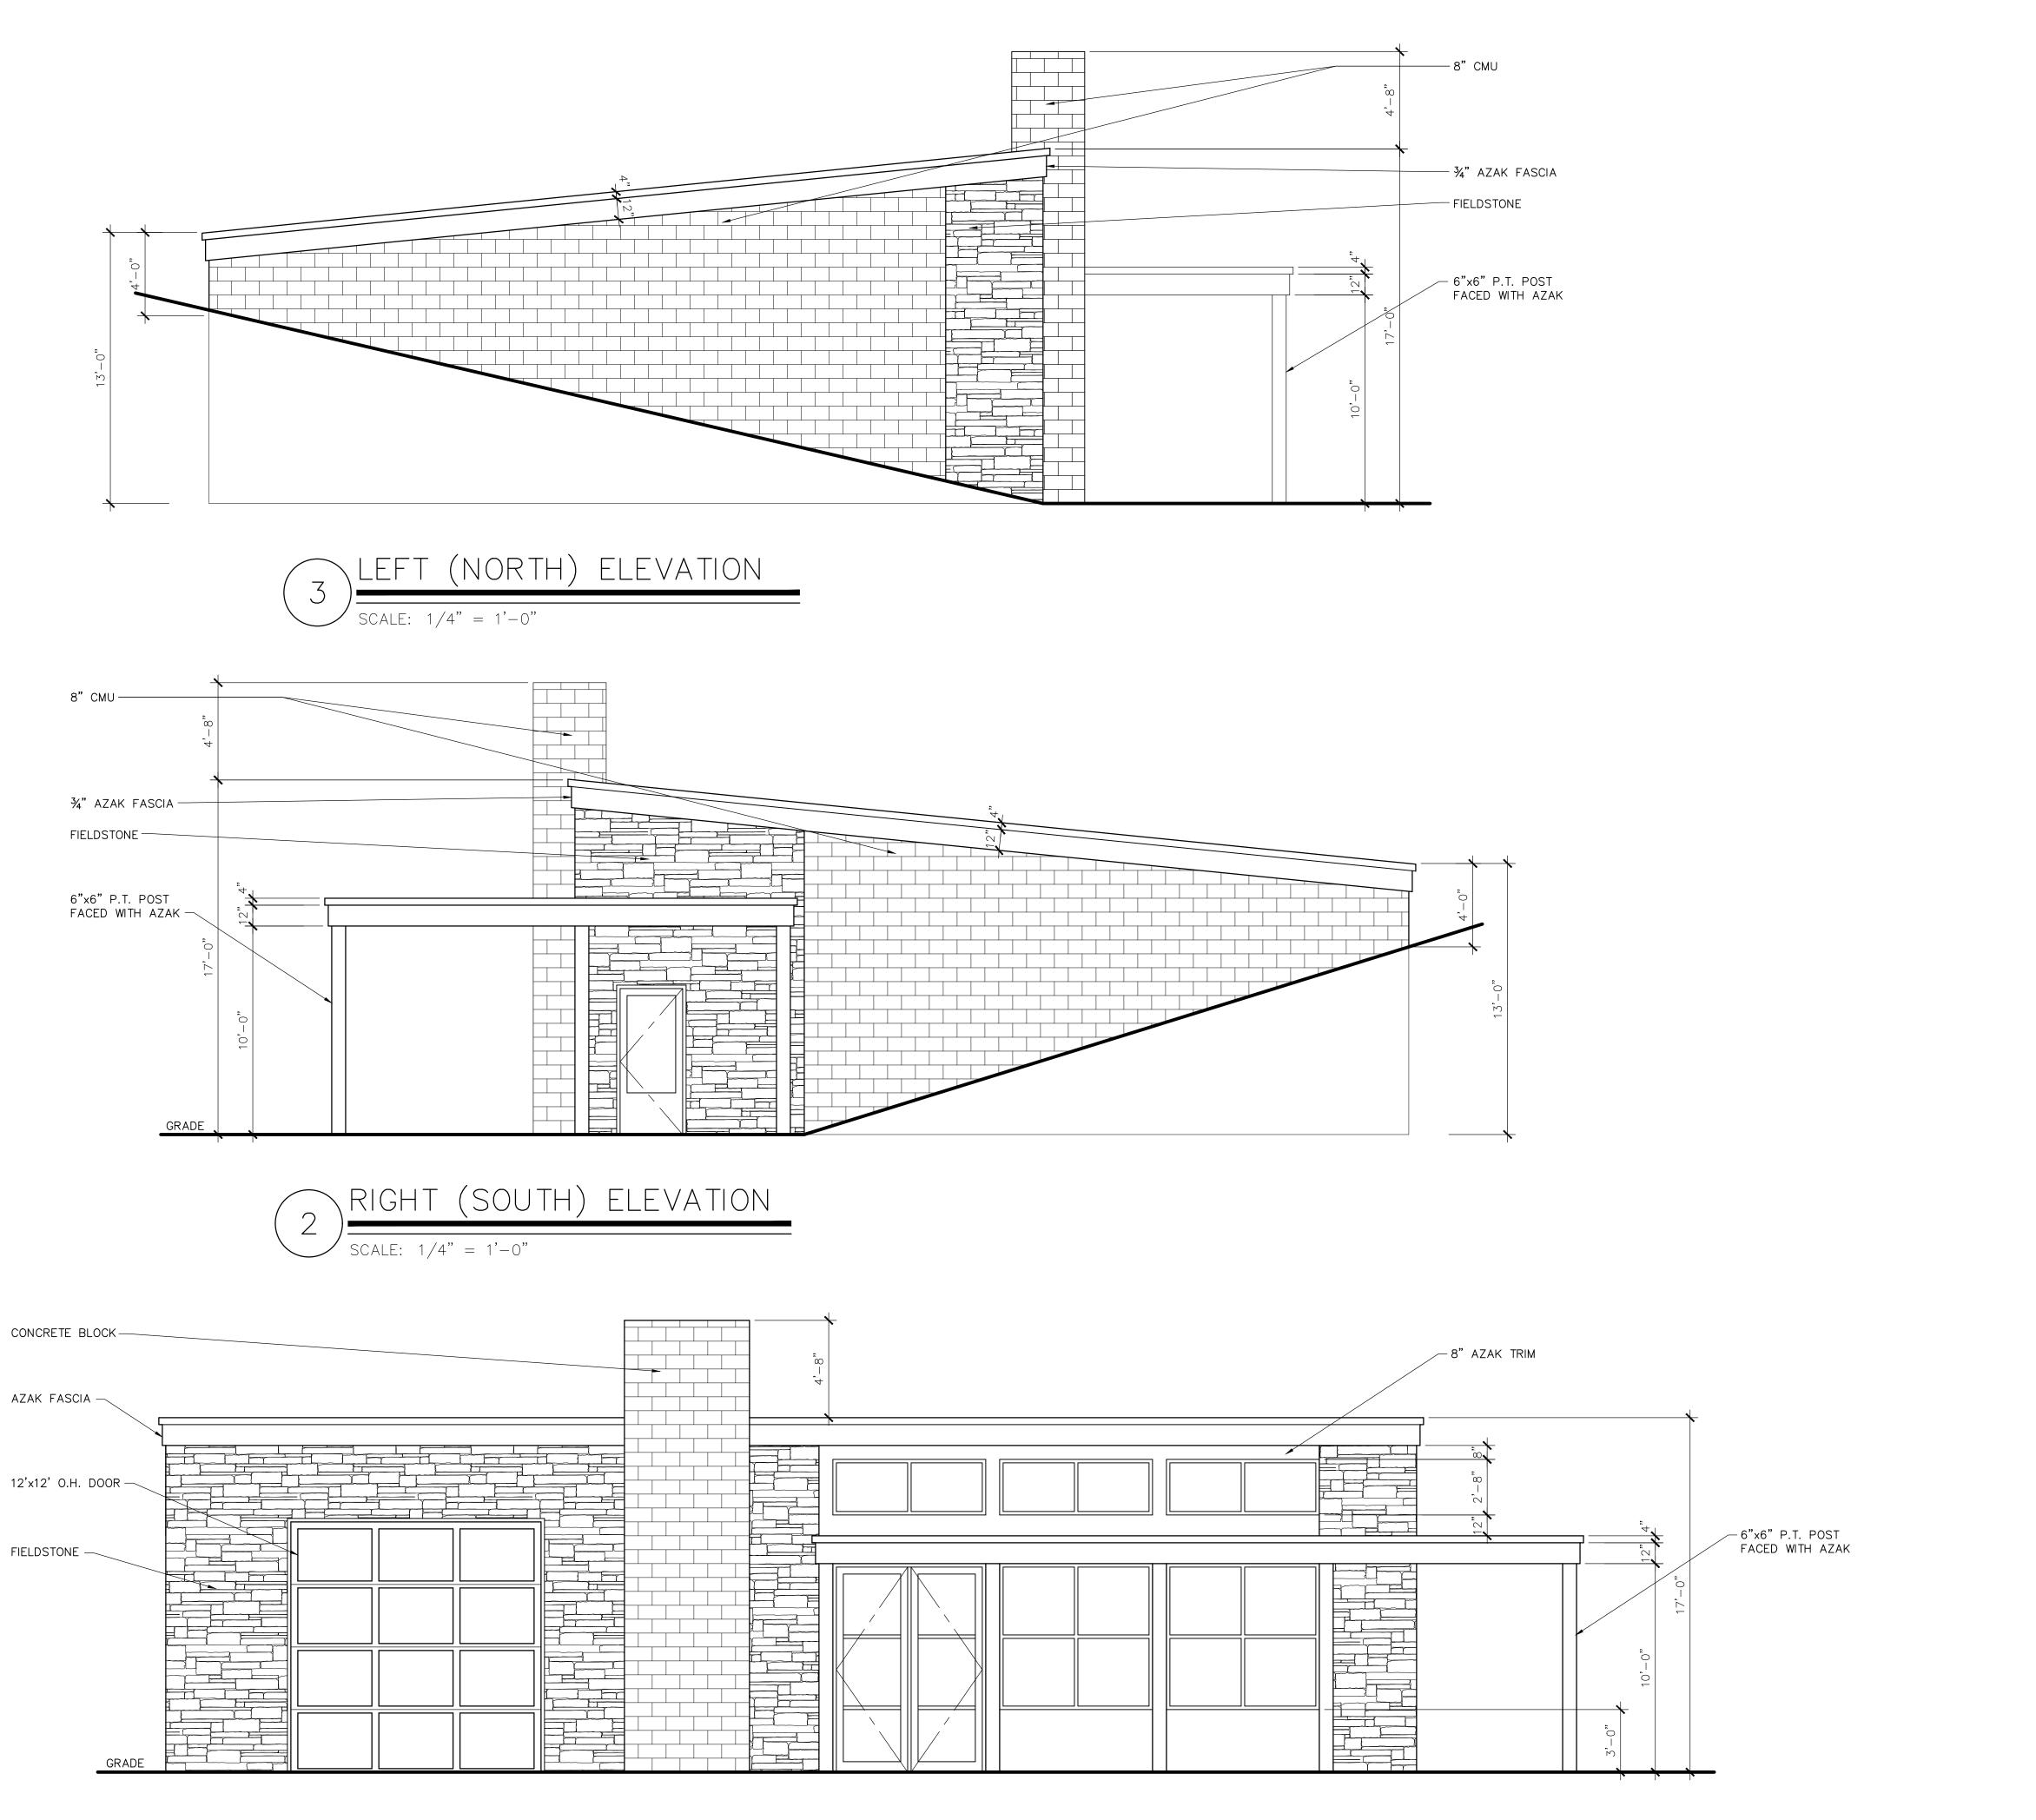

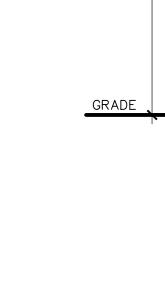


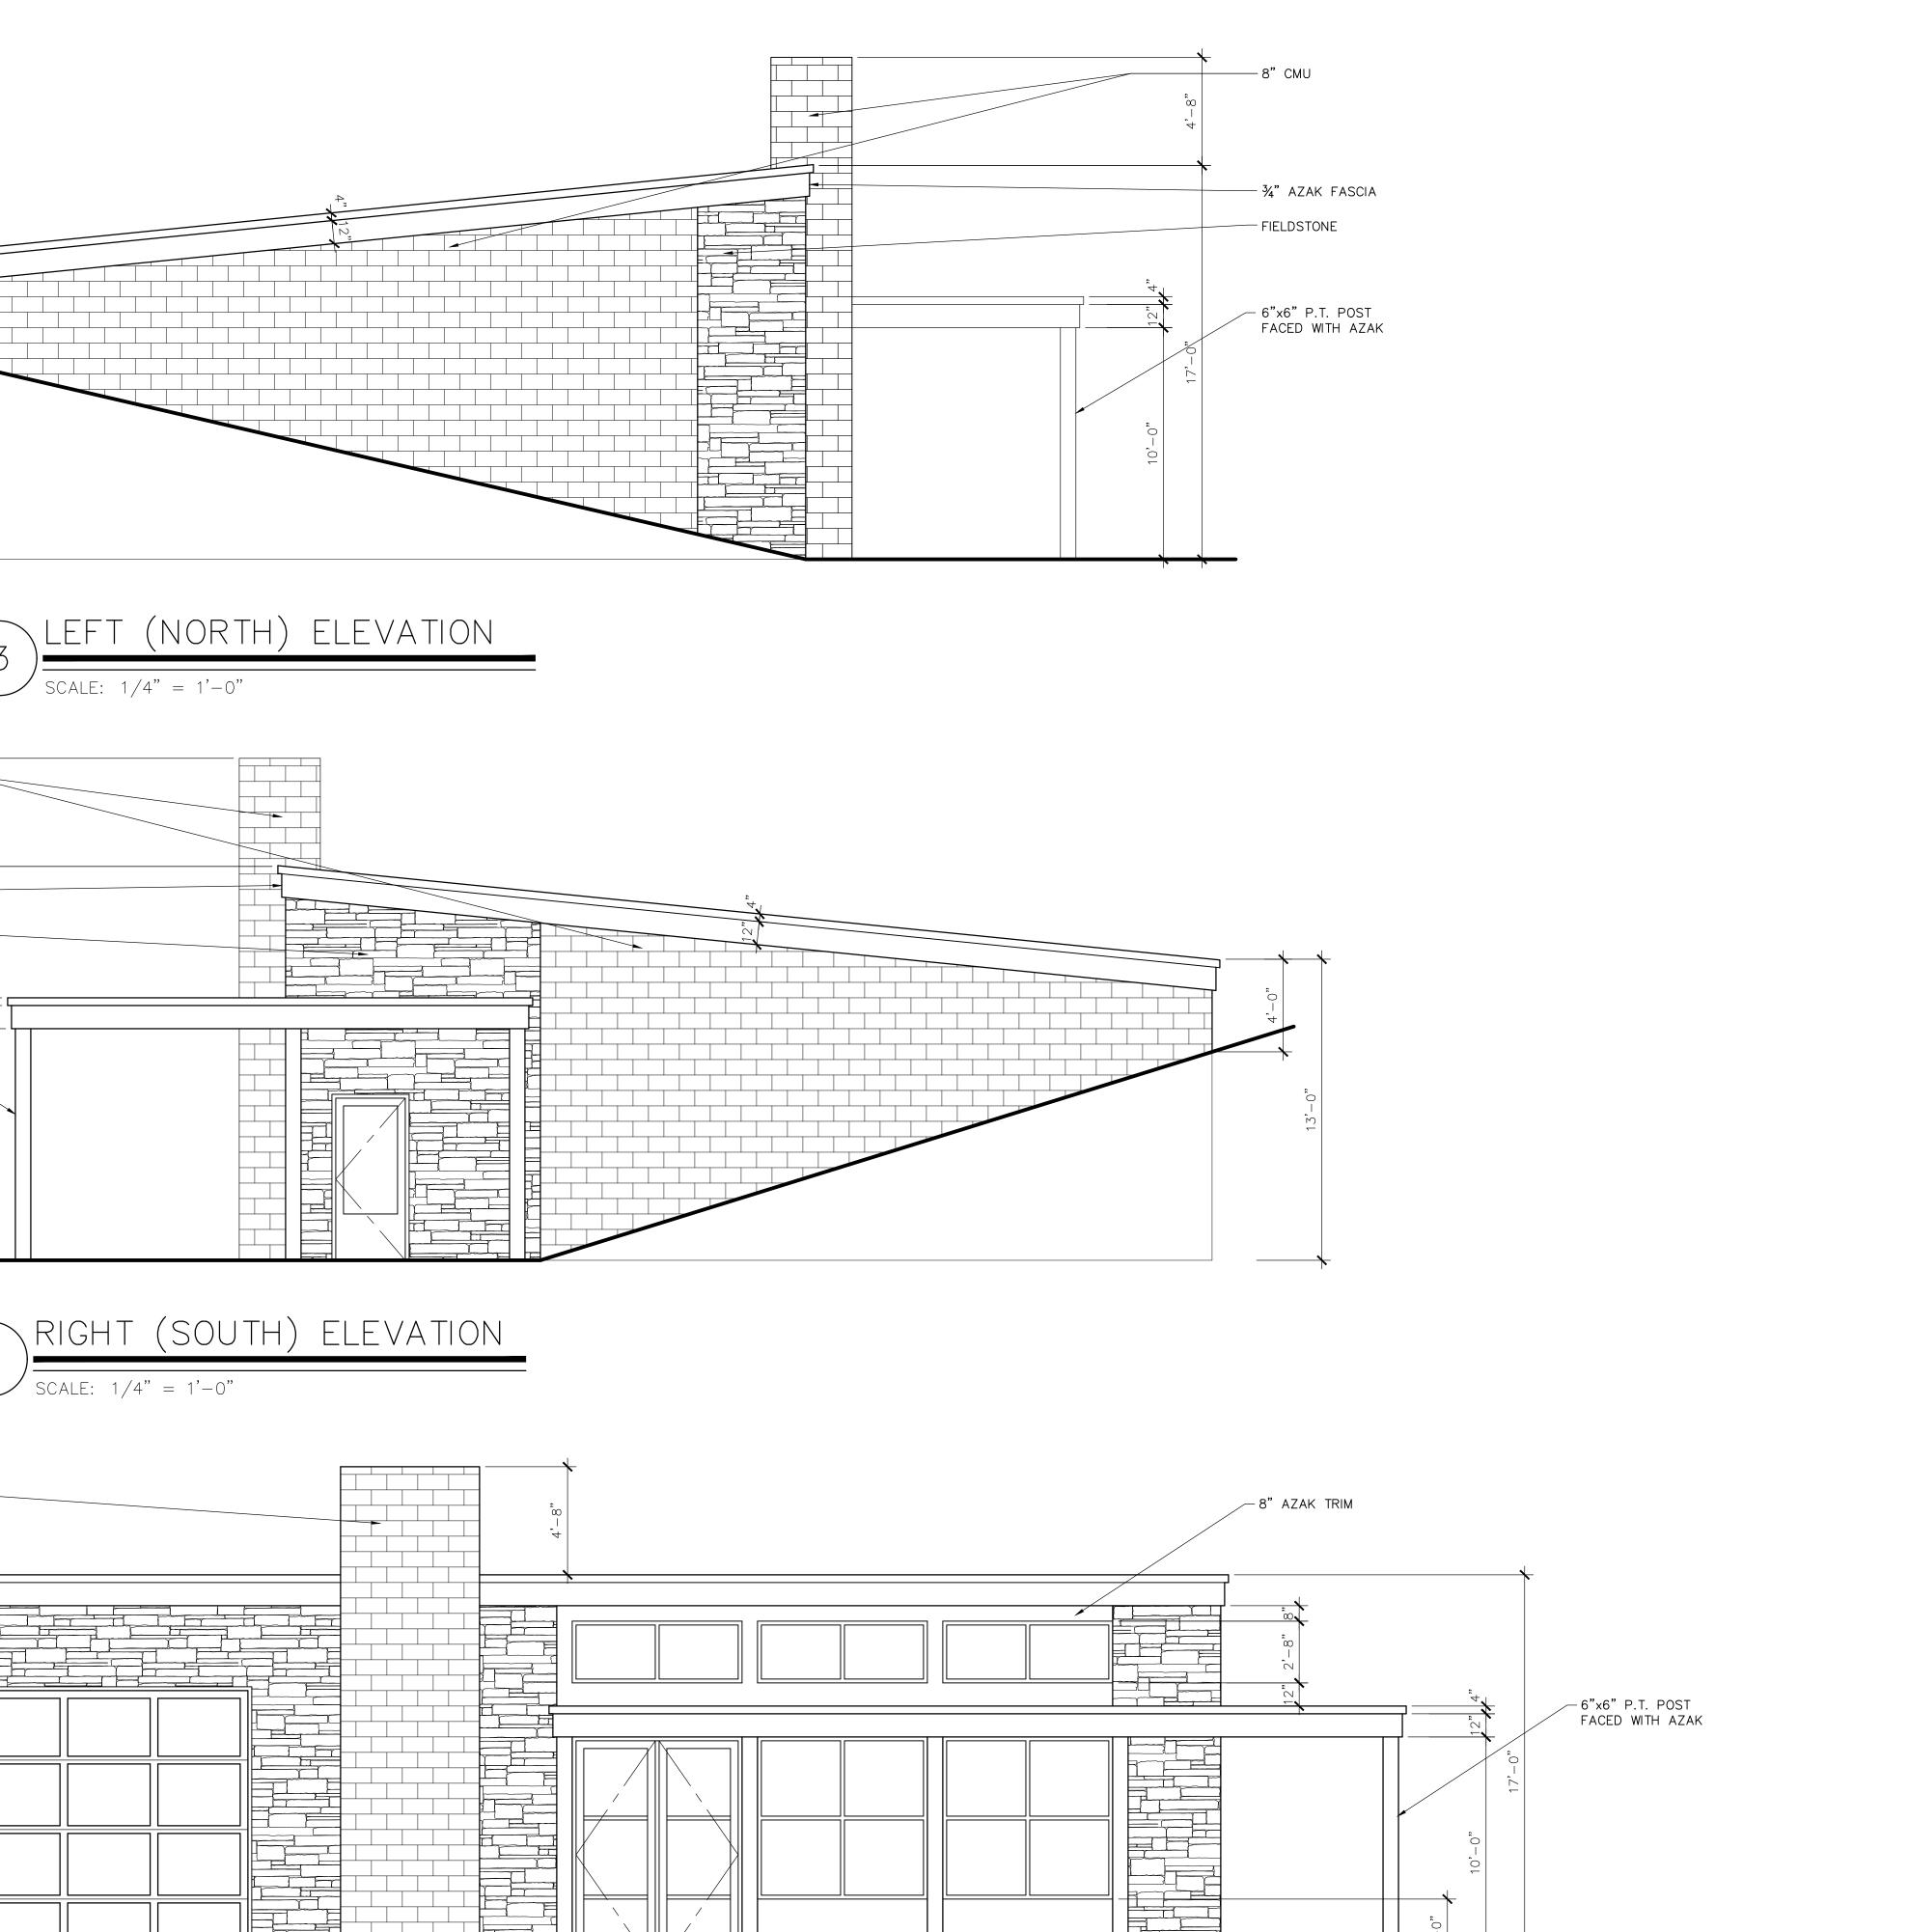

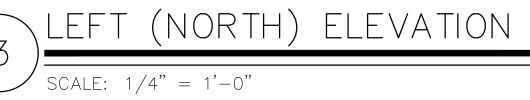

FRONT (WEST) ELEVATION

SCALE: 1/4" = 1'-0"

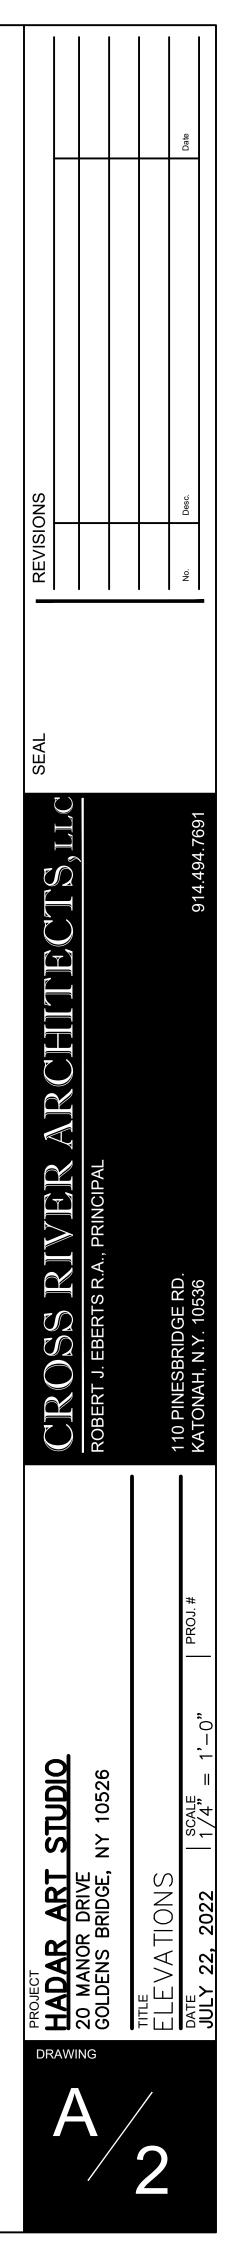



| SITE SYMBOL LEGEND | | | | | |
|--------------------|---|--|--|--|--|
| SYMBOL | DESCRIPTION | | | | |
| | PROPERTY LINE | | | | |
| | SETBACK LINE | | | | |
| 460 | EXISTING CONTOUR | | | | |
| (454) | NEW CONTOUR | | | | |
| — ני/ם | LINE OF DISTURBANCE | | | | |
| | SILT FENCE | | | | |
| | EXISTING STRUCTURE | | | | |
| 777777 | PROPOSED STRUCTURE | | | | |
| • | EXISTING TREE TO REMAIN | | | | |
| × | EXISTING TREE TO BE REMOVED | | | | |
| ·E | PROPOSED UNDERGROUND ELECTRICAL SERVICE | | | | |
| w | PROPOSED UNDERGROUND WATER LINE | | | | |

| TAX LOT – SECTION 7, BLOCK 11137, LOT 166 | | | ZONE –R2A |
|---|-------------------|-------------------------------|------------------------|
| | REQUIRED | EXISTING | PROPOSED |
| MIN. LOT SIZE - | 2 ACRES | 13.213 ACRES 575,558.28 SF | NO CHANGE |
| WIDTH | 200' | 1040' +/- | NO CHANGE |
| YARDS | | | |
| FRONT(FROM CL STREET) | 75' | 560.0' +/- | 630' +/- |
| FRONT (FROM PROPERTY LINE) | 50' | 60.0' +/- | 65.0' |
| SIDE | 40' | 160.0' +/- | 420.0' +/-/ 553.0' +/- |
| REAR | 50' | 500.0' +/- | 290.0 +/- |
| MAXIMUM ACCESSORY BLDG HEIGHT | 20' | - | 17' |
| MAX. BLDG COVERAGE | 9% / 51,800 SF | 0.77%, 4,850 SF | 1.26 %, 7,250 SF |
| FLOOR AREA OF RESIDENCE | | 7,456 SF | |
| FLOOR AREA OF ACCESSORY STUDIO BLDG | 600 SF | | 2,412 SF * |
| AREA OF RESIDENCE FOR HOME OCCUPATION | 30% OR 500 SF MAX | | 2.412 SF ** |

VARIANCES REQUESTED

* SECTION 220-23.D (1) c - 1,812 SF VARIANCE REQUESTED ** SECTION 220-23.D (1) c - 1,912 SF VARIANCE REQUESTED

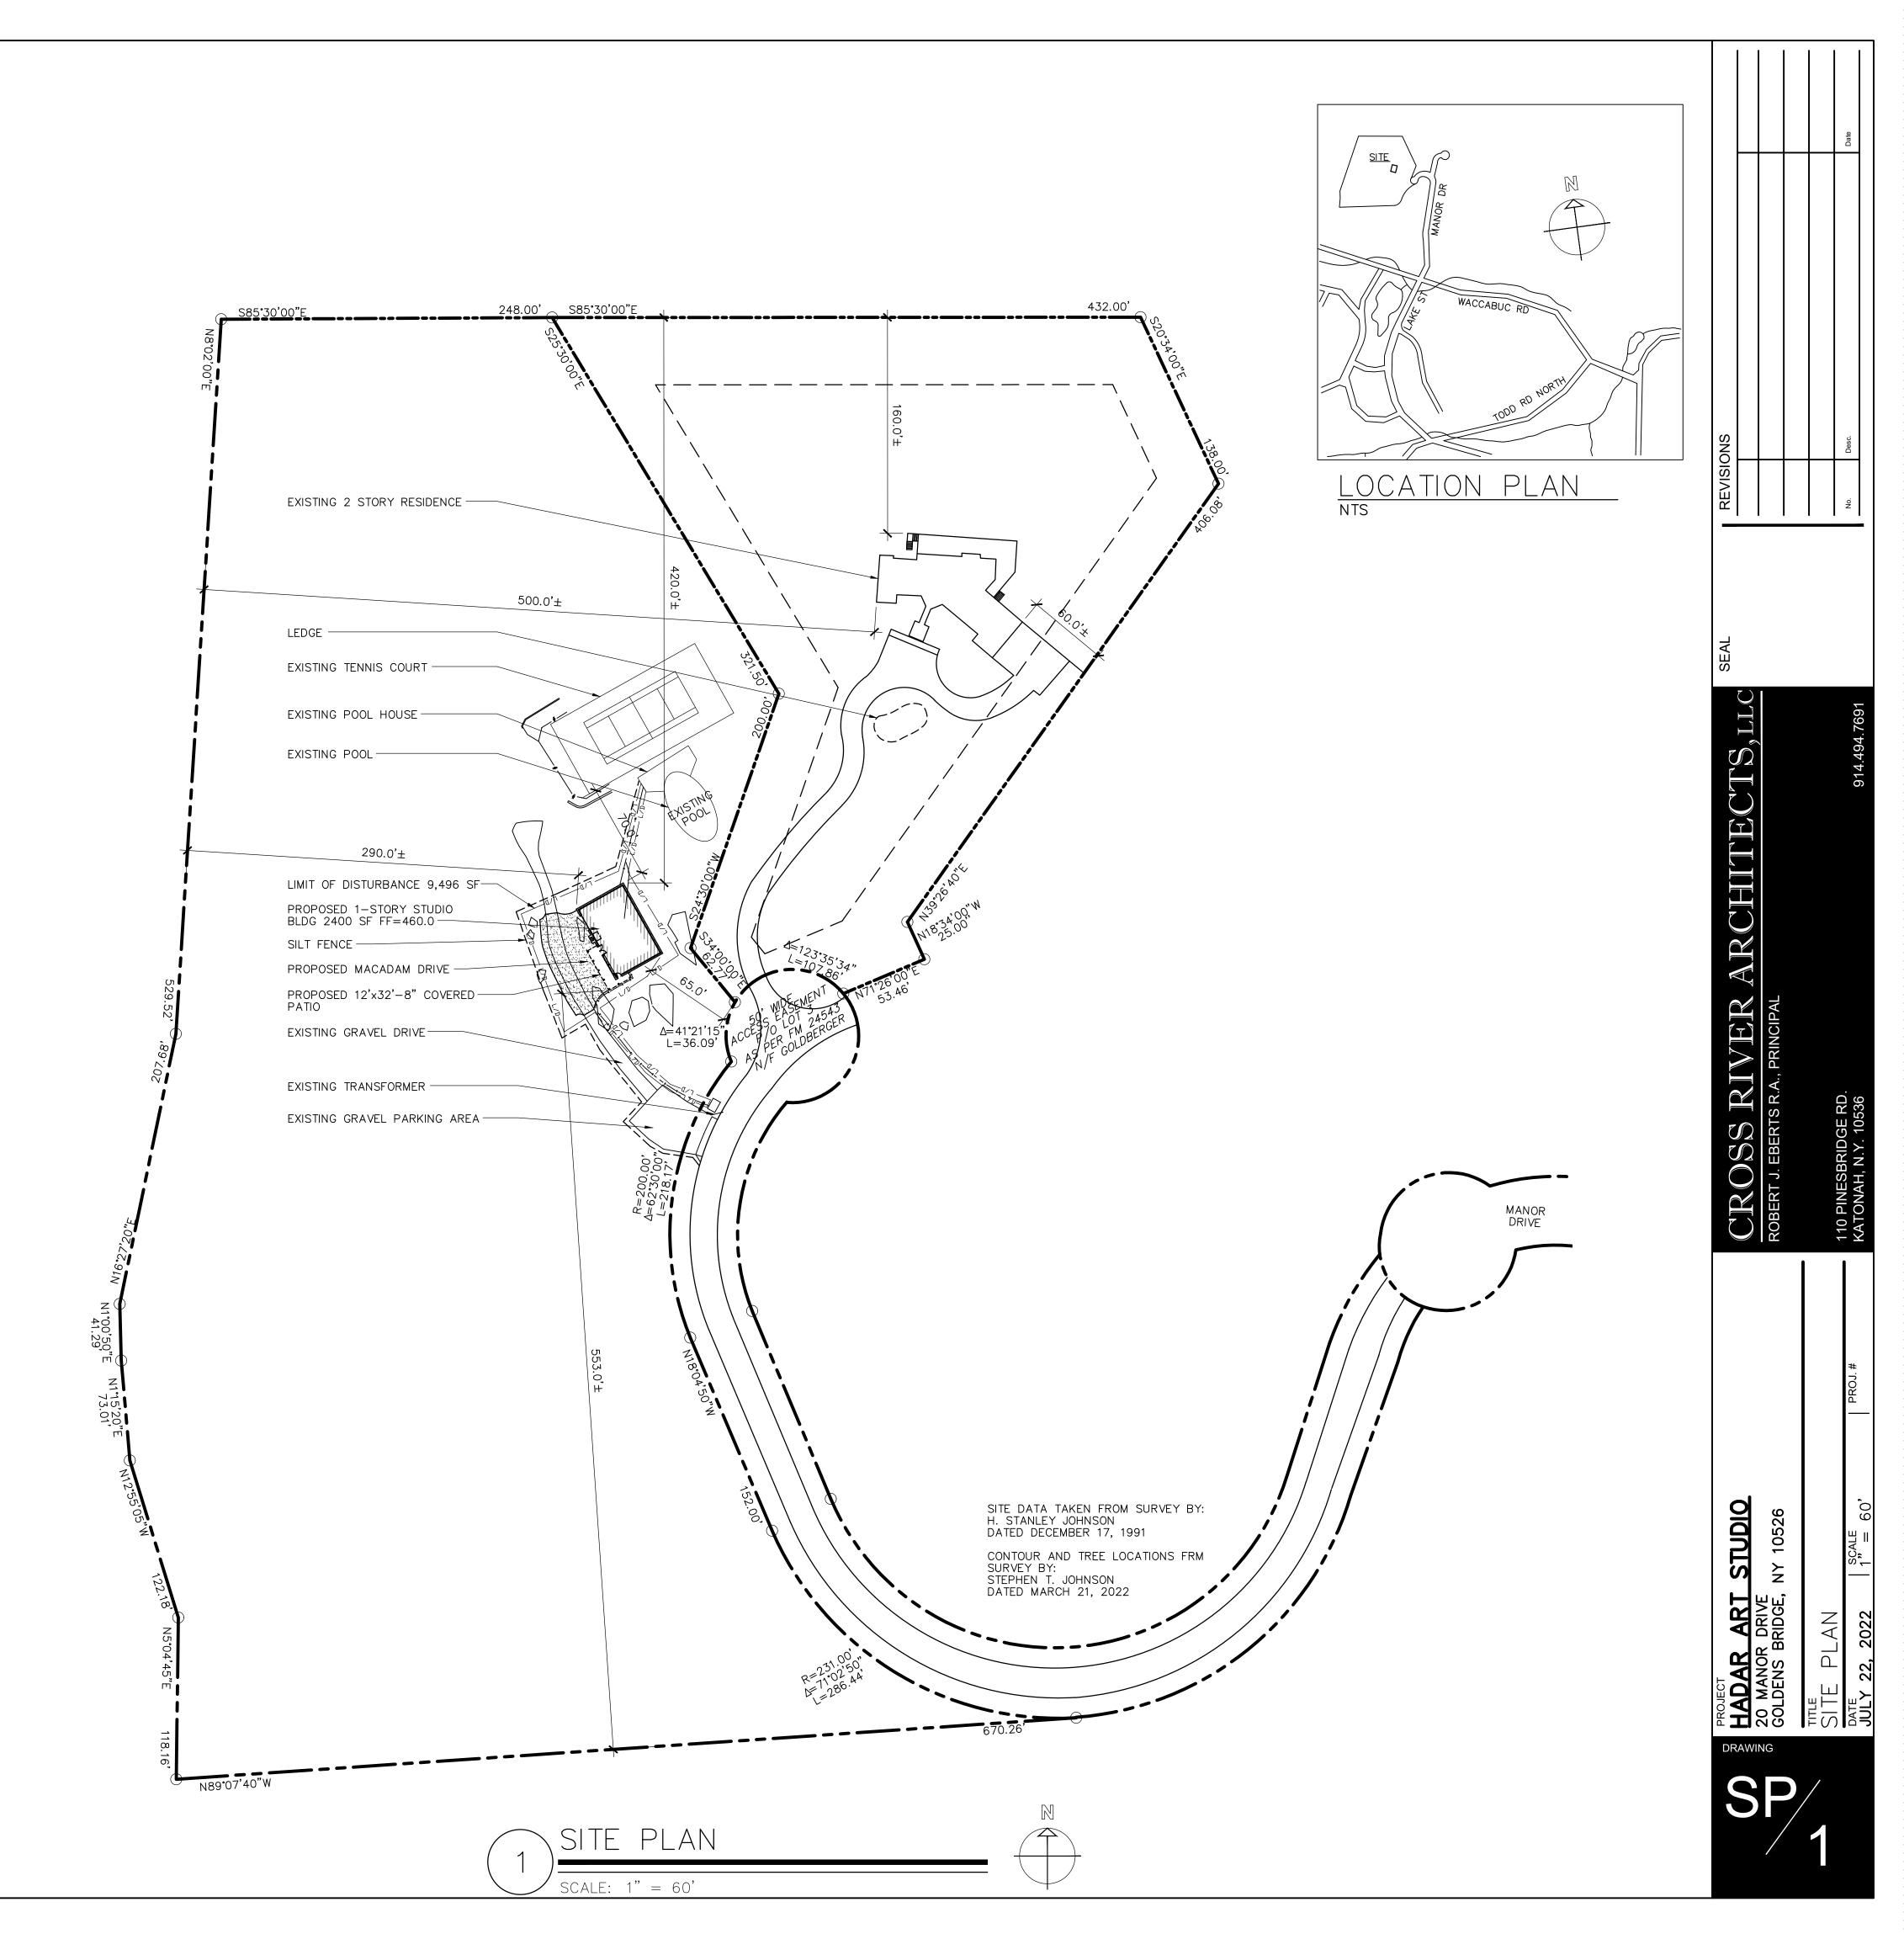

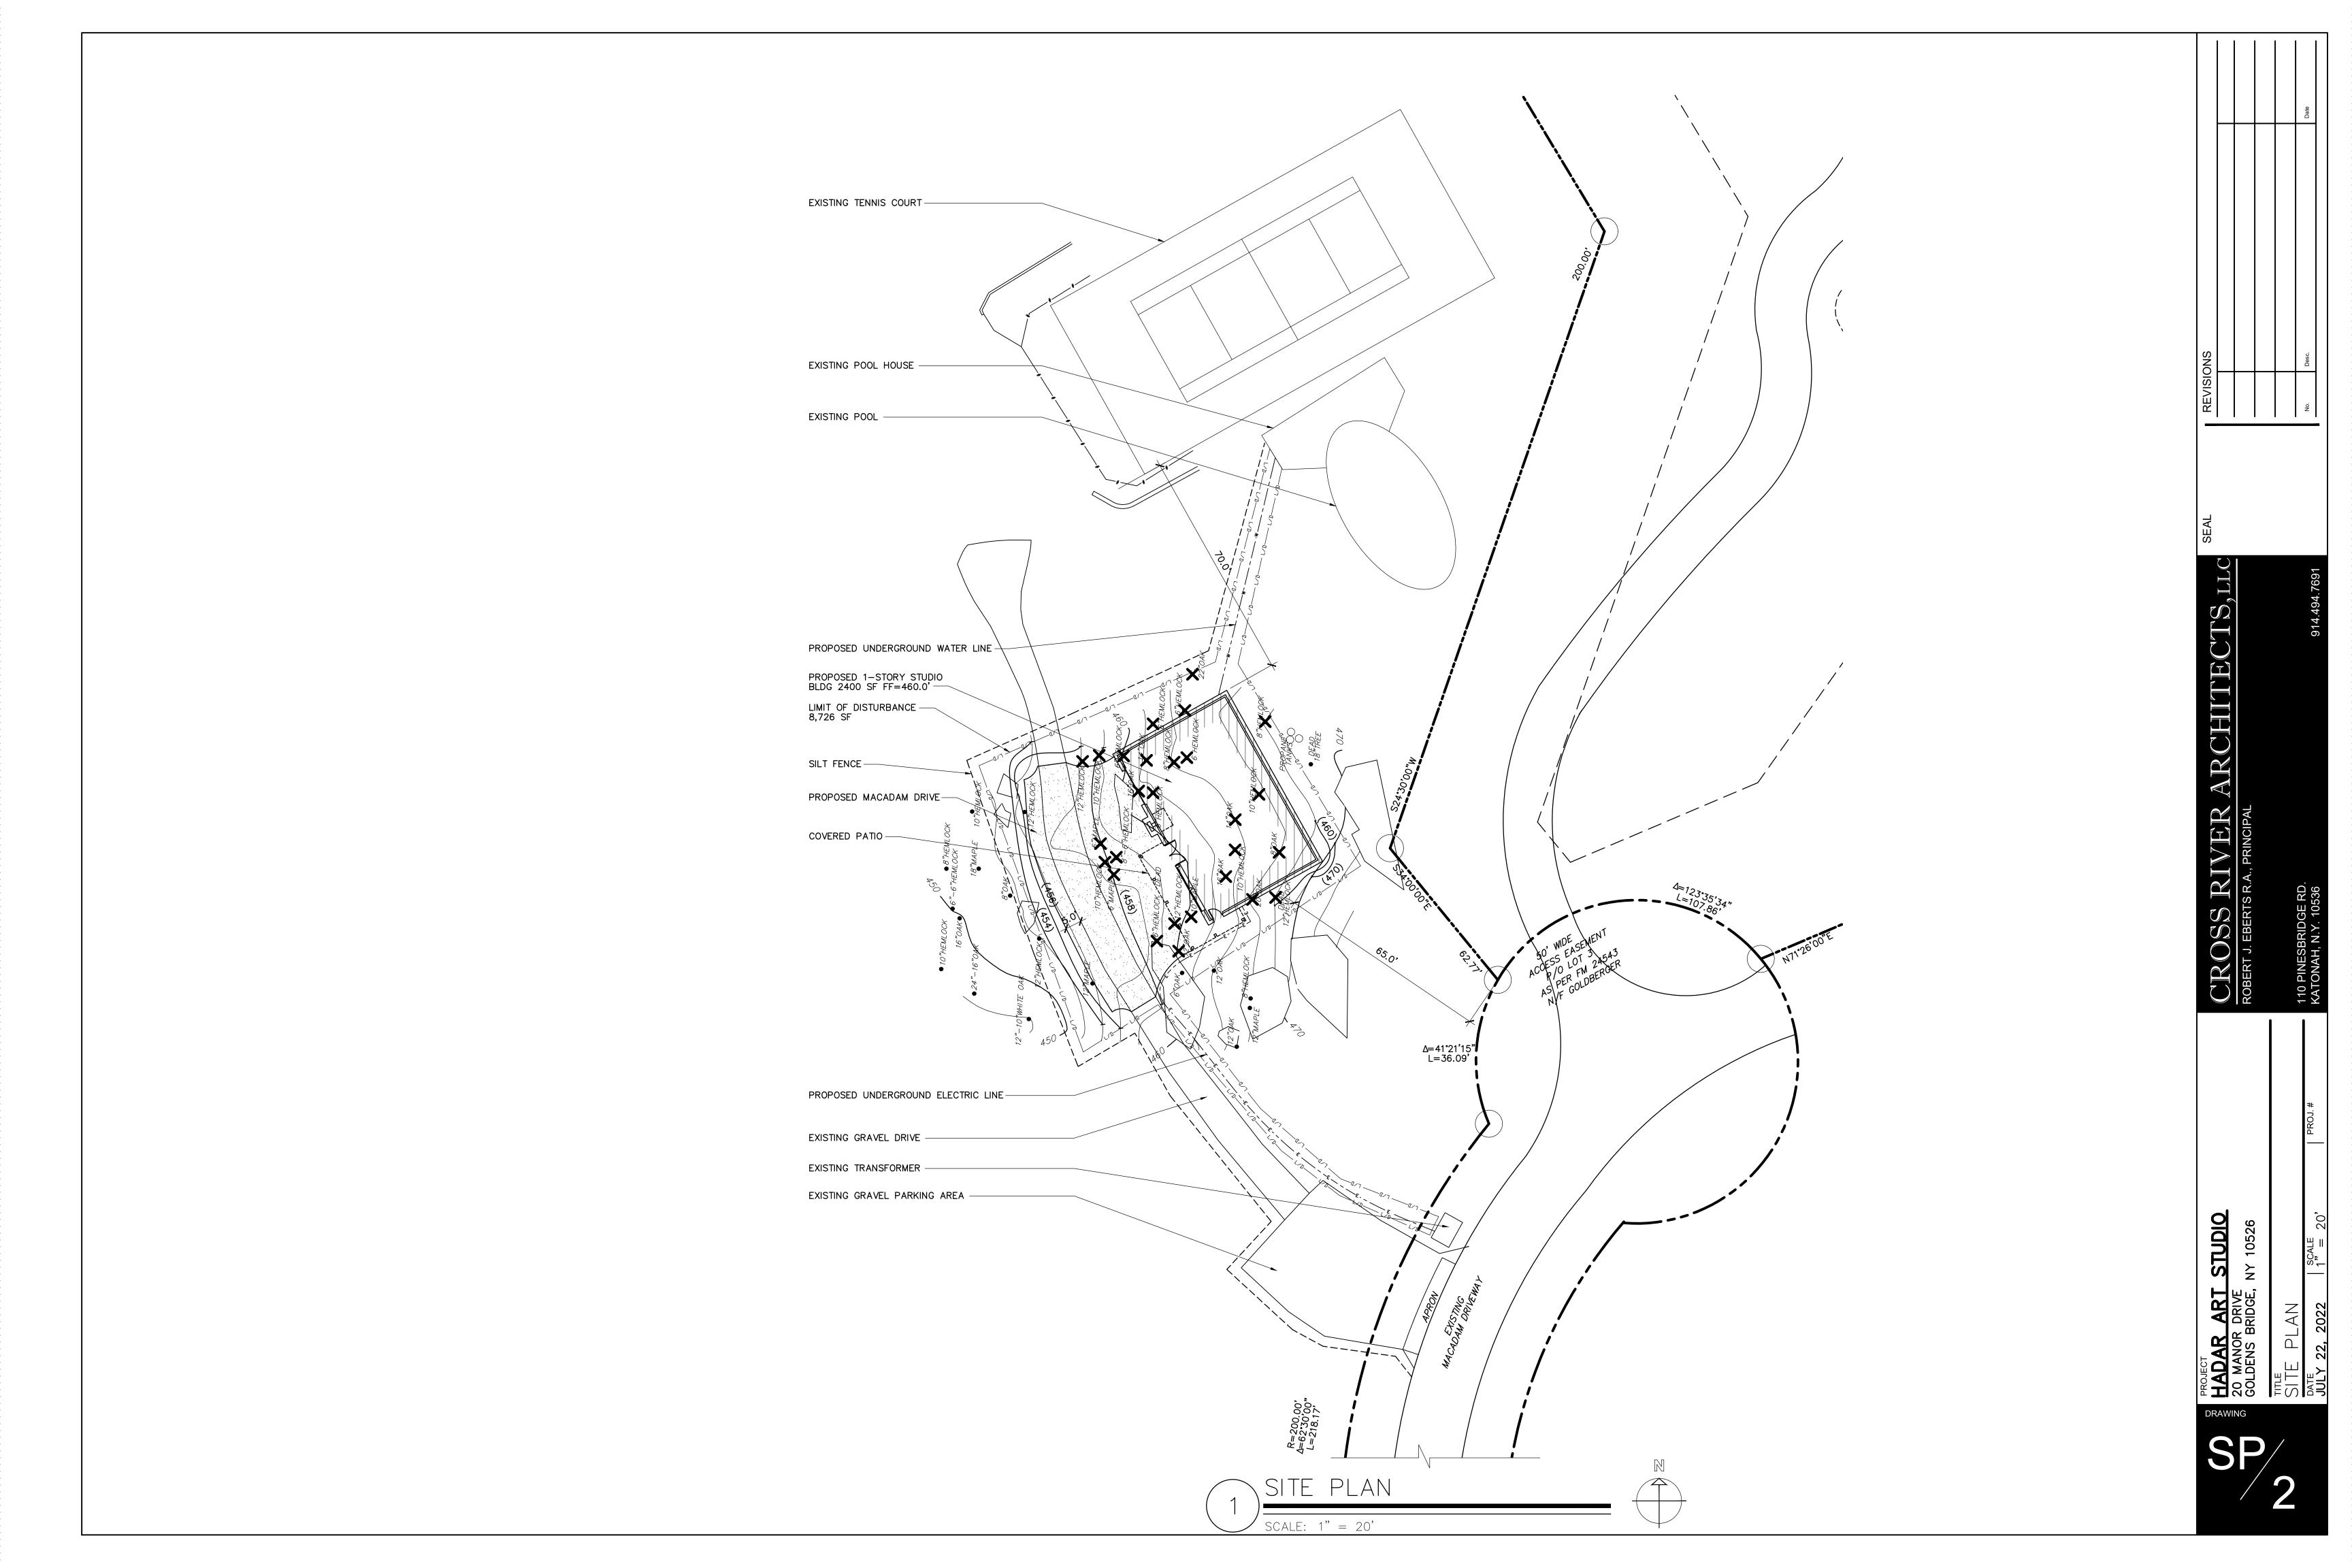



Building Department

South Salem, New York 10590

79 Bouton Road

Tel: (914) 763-3060 Fax: (914) 875-9148 Email: jfarrell@lewisborogov.com

Zoning Denial 8/25/2022

<u>Stephen Cipes (Goldens Bridge Shopping Center)</u> <u>104 Route 22, Goldens Bridge</u> 0004-11126-007

The applicant has proposed EV charging stations with associated electrical structures and is requesting a front yard setback of 3'10" whereas 20' are required per Article IV Section 220-24E of the Town of Lewisboro Zoning Code.

Building Inspector

Jeff Farrell

ZONING BOARD OF APPEALS

NOTICE OF PUBLIC HEARINGS

NOTICE IS HEREBY GIVEN, that the Zoning Board of Appeals of the Town of Lewisboro will host a Public Hearing on Wednesday, September 28, 2022, at 7:30 p.m., 79 Bouton Road, South Salem, New York, Justice Court.

CAL. NO. 27-22-BZ

Application of Plug In Stations, Brian Fetterman, [Cipes, Stephen, owner of record, Goldens Bridge Shopping Center], 104 Route 22, Goldens Bridge, NY for the following variance of the proposed EV charging stations with associated electrical structures and is requesting a front yard setback of 3'10" whereas 20' are required per Article IV Section 220-24E of the Town of Lewisboro Zoning Code.


The property is located on the east side of (#104) Route 22, Goldens Bridge, NY designated on the Tax Map as Sheet 0004, Block 11126, Lot 007, in an RB, Retail Business District consisting of approximately 8.961 acres.

Additional information regarding this application may be obtained from the Secretary to the Zoning Board of Appeals, 79 Bouton Road, South Salem, New York during regular business hours. At such Hearing, all interested parties may attend and will be heard.

Dated this 31st day of August 2022 in South Salem, New York

ZONING BOARD OF APPEALS TOWN OF LEWISBORO By: ROBIN PRICE, JR. CHAIR

The Town of Lewisboro is committed to equal access for all citizens. Anyone needing accommodations to attend or participate in this meeting is encouraged to notify the Secretary to the Zoning Board of Appeals in advance.

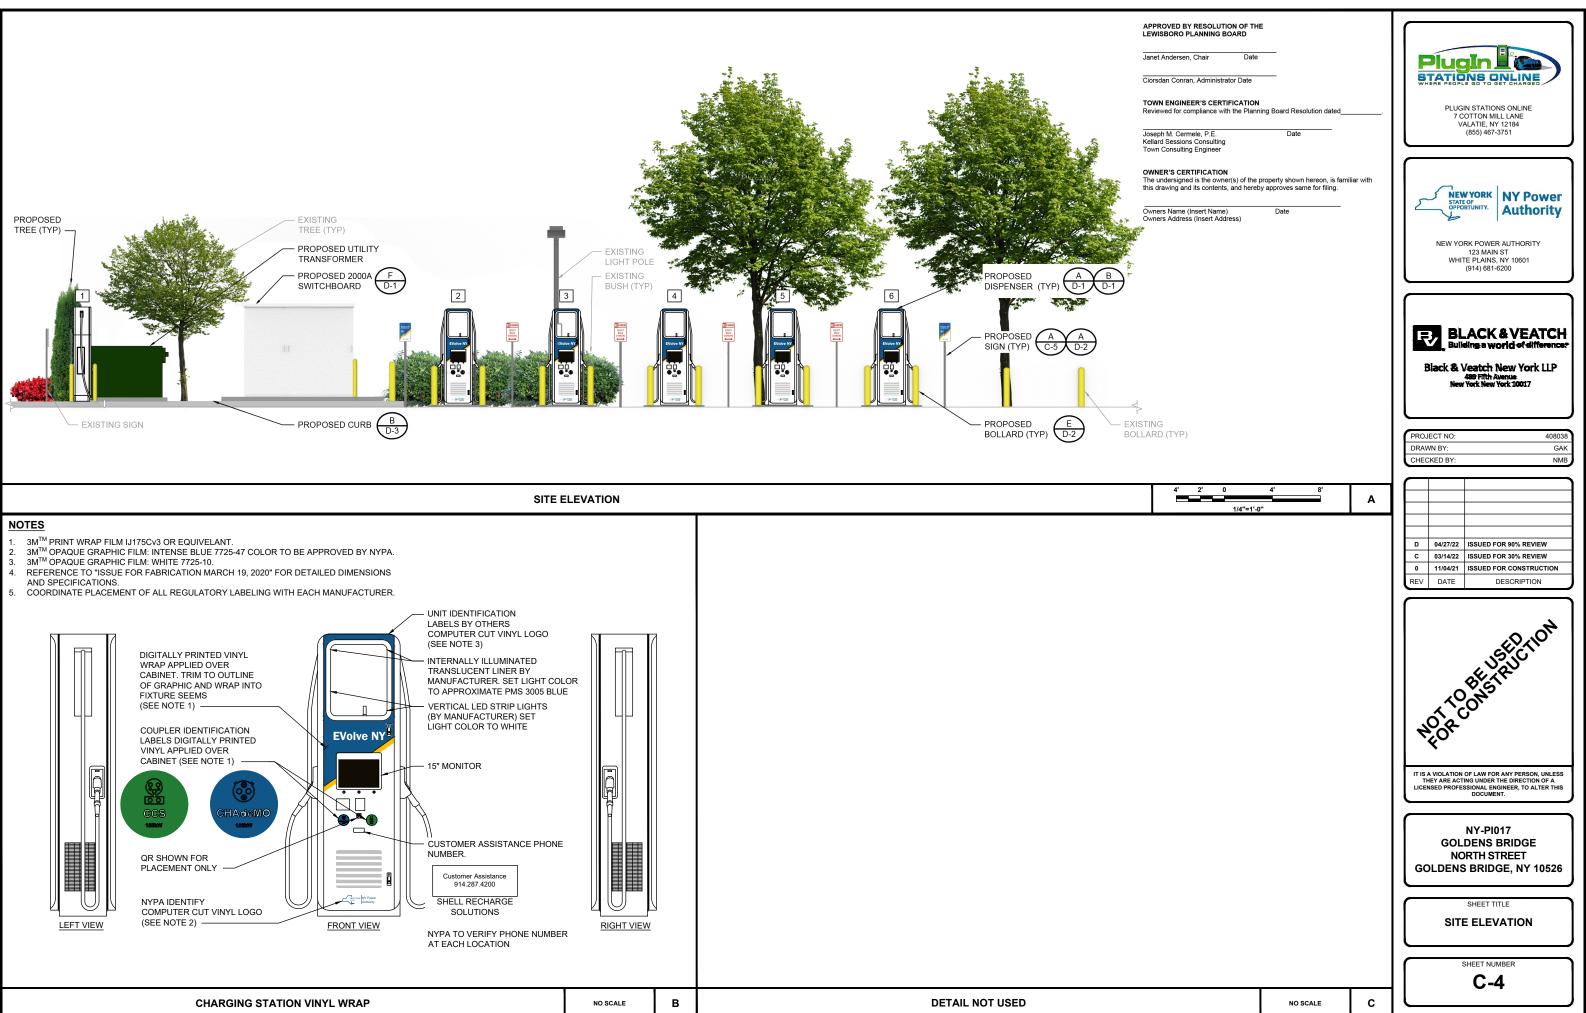

Janet Andersen, Chair

Joseph M. Cermele, P.E.

Owners Name (Insert Name

NY-PI017 GOLDENS BRIDGE **INSTALLATION OF ELECTRIC VEHICLE CHARGING EQUIPMENT GOLDENS BRIDGE** NORTH STREET **GOLDENS BRIDGE, NY 10526**

STATIONS ONLINE

WHERE PEOPLE GO TO GET CHARGED

=

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SPECIAL INSPECTION REQUIREMENTS

- CONCRETE PLACEMENT AND COMPRESSION TEST (PERIODIC) - POST INSTALLED ANCHORS (PERIODIC)

| OITE NEODU | | 1 | | | 1 | | LOCATION |
|---|--|---|--|------------|--|---|--|
| SITE INFORM | | | | AREA | AREA MAP | | |
| EV SITE ADDRESS: NORTH STREET GOLDENS BRIDGE, NY 10526 PROPERTY OWNER: CIPES STEPHEN POWER COMPANY: | LATITUDE: 41° 17' 38.60" N 41.294056* LONGITUDE: 73° 40' 29.00" W -73.674713° | INSTALL (INSTALL (INSTALL (INSTALL (| 1) UTILITY TRANSFORMER 1) SWITCHBOARD ASSEMBLY 3) 175KW SIGNET POWER UNITS 2) 350KW SIGNET DISPENSERS 4) 175KW SIGNET DISPENSERS | | | GREEN HILL RD | Careedina Sa Contractor |
| NYSEG | LEAD CIVIL ENGINEER: JOE HAMPSON | | DRAWING INDEX | | | GREEN ST | Station - East Lot |
| COUNTY: WESTCHESTER COUNTY | (913) 458-8092 HAMPSONJ@BV.COM | SHEET NO: | SHEET TITLE | REV NO: | MA Comp | ANDERSON LN | |
| CHARGER OWNER/OPERATOR: | LEAD ELEC. ENGINEER: | T-1 | TITLE SHEET & PROJECT DATA | E | A Part of the second se | in the second | |
| NYPA | GREG KRUG | GN-1 | GENERAL NOTES 1 | E | | WACCABUC | The state of the second |
| | (913) 458-2881 | GN-2 | GENERAL NOTES 2 | E | | - | North St |
| | KRUGGD@BV.COM | GN-3 | GENERAL NOTES 3 | E | Now The St | | SI ^T |
| | | C-0 | PARCEL SITE PLAN | E | 5 | | |
| | | C-1 | OVERALL SITE PLAN | E | | | |
| APPLICABLE | CODES | C-2 | DEMOLITION SITE PLAN | E | | N | |
| APPLICABLE | CODES | C-3 | ENLARGED SITE PLAN | E | 1 | SITE | |
| ALL WORK SHALL COMPLY WITH T | HE FOLLOWING | C-4 | SITE ELEVATION | E | | | CERTAIN |
| APPLICABLE CODES: | | C-5 | ACCESSIBILITY DETAILS | E | | Gokiens Bridge | A GME Markets |
| | | E-1 | ELECTRICAL PLAN | E | | * | |
| 2020 BUILDING CODE OF NEW YOR | | E-2 | SINGLE LINE DIAGRAM | E | PARKAVE | | |
| 2020 PLUMBING CODE OF NEW YO 2020 MECHANICAL CODE OF NEW | | E-3 | ELECTRICAL DETAILS | E | | | |
| 2017 ELECTRICAL CODE OF NEW Y | | E-4 | ELECTRICAL DETAILS | E | 1 3 | | Coldens BridgeR |
| 2020 FIRE CODE OF NEW YORK ST. | | G-1 | GROUNDING DETAILS | E | 11 00 | | |
| 2020 ENERGY CONSERVATION CO | NSTRUCTION CODE OF | D-1 | EQUIPMENT DETAILS | E | | | |
| NEW YORK STATE | | D-2 | EQUIPMENT DETAILS | E | 146 11 11 11 11 | | |
| IN THE EVENT OF CONFLICT, THE N SHALL PREVAIL | MOST RESTRICTIVE CODE | D-3 | EQUIPMENT DETAILS | E | MADOW ST | | Ű |
| ZONING INFOR | MATION | | | | | | |
| PERMITTING JURISDICTION: | CITY OF GOLDENS BRIDGE | | | | ž III. | | |
| | | | FOR REFERENCE ONLY DRAWINGS | | er 1 | | |
| FLOOD HAZARD A | | ELECTRIC UTIL | | | | | |
| | | PROPERTY SUI ABB EQUIPMEN | RVEY JT SPECIFICATIONS | | | (\land) | |
| THIS SITE IS LOCATED IN AREA DETERMINED TO BE 0.2% ANNUAL CHANCE | OUTSIDE OF THE | ABB SWITCHBO THE FORT MILL NYSEG REQUIF | | | | N | |
| CONTRACTOR | RNOTE | | ENGINEER OF RECORD | | CALL BEFOR | E YOU DIG | DO NOT SCALE I |
| CONTRACTOR SHALL COMPLETE I AND THE SEALED SET OF DRAW DEVIATIONS FROM THE DRAWING (HROUGH AN RFI REQUEST PROCES AN APPROVAL PRIOR TO CONTRAC | 'INGS. ANY NECESSARY GS MUST BE SUBMITTED SS WITH ENGINEERING FOR | ROBERT WOO PE # 094422 BLACK & VEAT | DS CH NY, LEP / CERTIFICATE #0009058 | | UTILITY NOTIFICATIO | ND SERVICE ALERT DN CENTER OF NEW YORK 1-800-962-7982 | CONTRACTOR SHALL VERIFY ALL PL/ CONDITIONS ON THE JOB SITE & SHA ENGINEER IN WRITING OF ANY DISCREPAI THE WOR |
| DEVIATION OF THE SIGNED AND SE | | | | | 3 WORKING DAYS UTILITY NOT | TIFICATION PRIOR TO CONSTRUCTION | 11"x17" PLOT WILL BE HALF |

PlugIn



GENERAL CONSTRUCTION NOTES

- FOR THE PURPOSE OF CONSTRUCTION DRAWINGS, THE FOLLOWING DEFINITIONS SHALL APPLY GENERAL CONTRACTOR: OVERLAND CONTRACTING INC. (BLACK & VEATCH) CONTRACTOR: (CONSTRUCTION) OWNER: ELECTRIEY AMERICA
- 2. ALL SITE WORK SHALL BE COMPLETED AS INDICATED ON THE DRAWINGS.
- 3. THE GENERAL CONTRACTOR SHALL VISIT THE SITE AND SHALL FAMILIARIZE THEMSELVES WITH ALL CONDITIONS AFFECTING THE PROPOSED WORK AND SHALL MAKE PROVISIONS, GENERAL CONTRACTOR SHALL BE RESPONSIBLE FOR FAMILIARIZING THEMSELVES WITH ALL CONTRACT DOCUMENTS, FIELD CONDITIONS, DIMENSIONS, AND CONFIRMING THAT THE WORK MAY BE ACCOMPUSHED AS SHOWN PRIOR TO PROCEEDING WITH CONSTRUCTION, ANY DISCREPANCIES SHALL BE BROUGHT TO THE ATTENTION OF THE ENGINEER PRIOR TO THE COMMENCEMENT OF WORK
- 4. ALL MATERIALS FURNISHED AND INSTALLED SHALL BE IN STRICT ACCORDANCE WITH ALL APPLICABLE CODES, REGULATIONS, AND ORDINANCES, GENERAL CONTRACTOR SHALL ISSUE ALL APPROPRIATE NOTICES AND COMPLY WITH ALL LAWS, ORDINANCES, RULES, REGULATIONS, AND LAWFUL ORDERS OF ANY PUBLIC AUTHORITY REGARDING THE PERFORMANCE OF WORK.
- ALL WORK CARRIED OUT SHALL COMPLY WITH ALL APPLICABLE MUNICIPAL AND UTILITY COMPANY SPECIFICATIONS AND LOCAL JURISDICTIONAL CODES, ORDINANCES, AND APPLICABLE REGULATIONS.
- UNLESS NOTED OTHERWISE, THE WORK SHALL INCLUDE FURNISHING MATERIALS, EQUIPMENT, APPURTENANCES, AND LABOR NECESSARY TO COMPLETE ALL INSTALLATIONS AS INDICATED ON THE DRAWINGS.
- PLANS ARE NOT TO BE SCALED. THESE PLANS ARE INTENDED TO BE A DIAGRAMMATIC OUTLINE ONLY UNLESS OTHERWISE NOTED. DIMENSIONS SHOWN ARE TO FINISH SURFACES UNLESS OTHERWISE NOTED. SPACING BETWEEN EQUIPMENT IS THE MINIMUM REQUIRED CLEARANCE THEREFORE, IT IS CRITICAL TO FIELD VERIFY DIMENSIONS, SHOULD THERE BE ANY QUESTIONS REGARDING THE CONTRACT DOCUMENTS, THE CONTRACTOR SHALL BE RESPONSIBLE FOR OBTAINING A CLARIFICATION FROM THE ENGINEER PRIOR TO PROCEEDING WITH THE WORK DETAILS ARE INTENDED TO SHOW DESIGN INTENT. MODIFICATIONS MAY BE REQUIRED TO SUIT JOB DIMENSIONS OR CONDITIONS AND SUCH MODIFICATIONS SHALL BE INCLUDED AS PART OF WORK AND PREPARED BY THE ENGINEER PRIOR TO PROCEEDING WITH WORK.
- 8. THE CONTRACTOR SHALL INSTALL ALL EQUIPMENT AND MATERIALS IN ACCORDANCE WITH MANUFACTURER'S RECOMMENDATIONS UNLESS SPECIFICALLY STATED OTHERWISE
- IF THE SPECIFIED EQUIPMENT CANNOT BE INSTALLED AS SHOWN ON THESE DRAWINGS, THE CONTRACTOR SHALL PROPOSE AN ALTERNATIVE INSTALLATION SPACE FOR APPROVAL BY THE ENGINEER PRIOR TO PROCEEDING.
- 10. THE GENERAL CONTRACTOR SHALL BE RESPONSIBLE FOR THE SAFETY OF WORK AREA, ADJACENT AREAS AND BUILDING OCCUPANTS THAT ARE LIKELY TO BE AFFECTED BY THE WORK UNDER THIS CONTRACT, WORK SHALL CONFORM TO ALL OSHA REQUIREMENTS AND THE LOCAL JURISDICTION
- 11. THE GENERAL CONTRACTOR SHALL COORDINATE WORK AND SCHEDULE WORK ACTIVITIES WITH OTHER DISCIPLINES.
- 12. CONSTRUCTION SHALL BE DONE IN A WORKMANLIKE MANNER BY COMPETENT EXPERIENCED WORKMAN IN ACCORDANCE WITH APPLICABLE CODES AND THE BEST ACCEPTED PRACTICE.
- 13. WORK PREVIOUSLY COMPLETED IS REPRESENTED BY LIGHT SHADED LINES AND NOTES. THE SCOPE OF WORK FOR THIS PROJECT IS REPRESENTED BY DARK SHADED LINES AND NOTES. CONTRACTOR SHALL NOTIFY THE GENERAL CONTRACTOR OF ANY EXISTING CONDITIONS THAT DEVIATE FROM THE DRAWINGS PRIOR TO BEGINNING CONSTRUCTION.
- 14. THE CONTRACTOR SHALL PROVIDE WRITTEN NOTICE TO THE CONSTRUCTION MANAGER 48 HOURS PRIOR TO COMMENCEMENT OF WORK.
- 15. THE CONTRACTOR SHALL PROTECT EXISTING IMPROVEMENTS, PAVEMENTS, CURBS LANDSCAPING AND STRUCTURES. ANY DAMAGED PART SHALL BE REPAIRED AT CONTRACTOR'S EXPENSE TO THE SATISFACTION OF THE OWNER.
- 16. THE CONTRACTOR SHALL CONTACT UTILITY LOCATING SERVICES PRIOR TO THE START OF CONSTRUCTION.
- 17. THE GENERAL CONTRACTOR SHALL COORDINATE AND MAINTAIN ACCESS FOR ALL TRADES AND CONTRACTORS TO THE SITE AND/OR BUILDING.
- 18. THE GENERAL CONTRACTOR SHALL BE RESPONSIBLE FOR SECURITY OF THE SITE FOR THE DURATION OF CONSTRUCTION UNTIL JOB COMPLETION.
- 19. THE GENERAL CONTRACTOR SHALL MAINTAIN IN GOOD CONDITION ONE COMPLETE SET OF PLANS WITH ALL REVISIONS, ADDENDA, AND CHANGE ORDERS ON THE PREMISES AT ALL TIMES.
- 20. THE CONTRACTOR SHALL PROVIDE PORTABLE FIRE EXTINGUISHERS WITH A RATING OF NOT LESS THAN 2-A:10-B:C AND SHALL BE WITHIN 25 FEET OF TRAVEL DISTANCE TO ALL PORTIONS OF WHERE THE WORK IS BEING COMPLETED DURING CONSTRUCTION.
- 21. ALL EXISTING ACTIVE SEWER, WATER, GAS, ELECTRIC, AND OTHER UTILITIES SHALL BE PROTECTED AT ALL TIMES, AND WHERE REQUIRED FOR THE PROPER EXECUTION OF THE WORK, SHALL BE RELOCATED AS DIRECTED BY THE ENGINEER. EXTREME CAUTION SHOULD BE USED BY THE CONTRACTOR WHEN EXCAVATING OR DRILLING PIERS AROUND OR NEAR UTILITIES. THE CONTRACTOR SHALL PROVIDE SAFETY TRAINING FOR THE WORKING CREW. THIS SHALL INCLUDE BUT NOT BE LIMITED TO A) FALL PROTECTION, B) CONFINED SPACE, C) ELECTRICAL SAFETY, AND D) TRENCHING & EXCAVATION.

GENERAL CONSTRUCTION NOTES CONT.

- 22. ALL EXISTING INACTIVE SEWER, WATER, GAS, ELECTRIC, AND OTHER UTILITIES, WHICH INTERFERE WITH THE EXECUTION OF THE WORK, SHALL BE REMOVED, CAPPED, PLUGGED OR OTHERWISE DISCONNECTED AT POINTS WHICH WILL NOT INTERFERE WITH THE EXECUTION OF THE WORK, AS DIRECTED BY THE ENGINEER, AND SUBJECT TO THE APPROVAL OF THE OWNER AND/OR LOCAL UTILITIES.
- 23. THE AREAS OF THE OWNER'S PROPERTY DISTURBED BY THE WORK AND NOT COVERED BY THE EQUIPMENT OR DRIVEWAY, SHALL BE GRADED TO A UNIFORM SLOPE, AND STABILIZED TO PREVENT EROSION
- 24. CONTRACTOR SHALL MINIMIZE DISTURBANCE TO THE EXISTING SITE DURING CONSTRUCTION. EROSION CONTROL MEASURES, IF REQUIRED DURING CONSTRUCTION, SHALL BE IN CONFORMANCE WITH THE FEDERAL AND LOCAL JURISDICTION FOR EROSION AND SEDIMENT CONTROL
- 25. NO FILL OR EMBANKMENT MATERIAL SHALL BE PLACED ON FROZEN GROUND, FROZEN MATERIALS, SNOW OR ICE SHALL NOT BE PLACED IN ANY FILL OR EMBANKMENT.
- 26. THE SUBGRADE SHALL BE BROUGHT TO A SMOOTH UNIFORM GRADE AND COMPACTED TO 95 PERCENT STANDARD PROCTOR DENSITY UNDER PAVEMENT AND STRUCTURES AND 80 PERCENT STANDARD PROCTOR DENSITY IN OPEN SPACE. ALL TRENCHES IN PUBLIC RIGHT OF WAY SHALL BE BACKFILLED WITH FLOWABLE FILL OR OTHER MATERIAL PRE-APPROVED BY THE LOCAL JURISDICTION
- 27. ALL NECESSARY RUBBISH, STUMPS, DEBRIS, STICKS, STONES, AND OTHER REFUSE SHALL BE REMOVED FROM THE SITE AND DISPOSED OF IN A LAWFUL MANNER.
- 28. ALL BROCHURES, OPERATING AND MAINTENANCE MANUALS, CATALOGS, SHOP DRAWINGS, AND OTHER DOCUMENTS SHALL BE TURNED OVER TO THE GENERAL CONTRACTOR AT COMPLETION OF CONSTRUCTION AND PRIOR TO PAYMENT
- 29. THE CONTRACTOR SHALL SUBMIT A COMPLETE SET OF AS-BUILT REDUNES TO THE GENERAL CONTRACTOR UPON COMPLETION OF PROJECT AND PRIOR TO FINAL PAYMENT.
- 30. THE CONTRACTOR SHALL LEAVE PREMISES IN A CLEAN CONDITION
- 31. THE PROPOSED FACILITY WILL BE UNMANNED AND DOES NOT REQUIRE POTABLE WATER OR SEWER SERVICE, AND IS NOT FOR HUMAN HABITATION (NO HANDICAP ACCESS REQUIRED).
- 32. NO OUTDOOR STORAGE OR SOLID WASTE CONTAINERS ARE PROPOSED
- 33. CONTRACTORS SHALL BE RESPONSIBLE FOR OBTAINING ALL PERMITS AND INSPECTIONS REQUIRED FOR CONSTRUCTION, IF CONTRACTOR CANNOT OBTAIN A PERMIT, THEY MUST NOTIFY THE GENERAL CONTRACTOR IMMEDIATELY.
- 34. THE CONTRACTOR SHALL REMOVE ALL TRASH AND DEBRIS FROM THE SITE ON A DAILY BASIS.
- 35. INFORMATION SHOWN ON THESE DRAWINGS WAS OBTAINED FROM SITE VISITS AND/OR DRAWINGS PROVIDED BY THE SITE OWNER. CONTRACTORS SHALL NOTIFY THE ENGINEER OF ANY DISCREPANCIES PRIOR TO ORDERING MATERIAL OR PROCEEDING WITH CONSTRUCTION.

STRUCTURAL STEEL NOTES

- 1. STRUCTURAL STEEL SHALL CONFORM TO THE FOLLOWING REQUIREMENTS, UNLESS NOTED OTHERWISE: WIDE FLANGE SHAPE: A992, 50ksi
 - ANGLE AND CHANNEL SHAPE: ASTM A36, 36 ksi PLATE: ASTM A36, 36ksi
 - PIPE: ASTM A53 GRADE B, 35 ksi
 - HSS: ASTM A500 GRADE B, 46ksi
- 2 HIGH-STRENGTH BOLTS SHALL CONFORM TO ASTM A325' ONE HIGH-STRENGTH BOLT ASSEMBLY SHALL CONSIST OF A HEAVY HEX STRUCTURAL BOLT, A HEAVY NUT, A HARDENED WASHER CONFORMING TO ASTM F436. THE HARDENED WASHER SHALL BE INSTALLED AGAINST ELEMENT TURNED IN TIGHTENING. UNLESS NOTED OTHERWISE ON THE DRAWINGS, ALL CONNECTIONS SHALL BE BEARING TYPE CONNECTIONS.
- WELDING ELECTRODES SHALL COMPLY WITH AWS D1.1 USING A5.1 OR A5.5 E70XX AND SHALL BE 3. COMPATIBLE WITH THE WELDING PROCESS SELECTED, WELDERS SHALL BE QUALIFIED AS PRESCRIBED IN AWS D1.1.
- 4. UNLESS NOTED OTHERWISE ON THE DRAWING, ALL ANCHOR BOLTS SHALL CONFORM TO ASTM F1554, GRADE 36, WITH HEAVY HEXAGONAL NUT.
- 5. FABRICATE ITEMS OF STRUCTURAL STEEL IN ACCORDANCE WITH AISC SPECIFICATION.
- 6. ALL EXPOSED STRUCTURAL STEEL, BOLTS, AND HARDWARE SHALL BE HOT DIP GALVANIZED PER ASTM A123.
- 7. SUBMIT FABRICATION AND ERECTION DRAWINGS SHOWING ALL DETAILS, CONNECTIONS, MATERIAL DESIGNATIONS, AND TOP STEEL ELEVATIONS FOR APPROVAL. THE SHOP DRAWINGS WILL BE REVIEWED FOR GENERAL CONFORMANCE TO THE CONTRACT DRAWINGS. SUCH APPROVAL SHALL NOT RELIEVE THE FABRICATOR/CONTRACTOR OF THE RESPONSIBILITY FOR EITHER THE ACCURACY OF THE DETAILED DIMENSIONS IN THE SHOP AND ERECTION DRAWINGS OR THE GENERAL FIT-UP OF PARTS THAT ARE TO BE ASSEMBLED IN THE FIELD.
- 8. PRIMER SHALL BE RED OXIDE-CHROMATE PRIME COMPLYING WITH STEEL STRUCTURES PAINTING COUNCIL (SSPC) PAINT SPECIFICATION NUMBER 11

APPROVED BY RESOLUTION OF THE LEWISBORO PLANNING BOARD

Janet Andersen, Chair Date

Ciorsdan Conran, Administrator Date

TOWN ENGINEER'S CERTIFICATION the Planning Board Resolution dated

Joseph M, Cermele, P,E Kellard Sessions Consulting Town Consulting Engineer

CONCRETE MASONRY NOTES


- 1. CONCRETE MASONRY UNITS SHALL BE MEDIUM WEIGHT UNITS CONFORMING TO ASTM C90, GRADE N-1, (F'M=1,500 PSI). MEDIUM WEIGHT. (115 PCF)
- 2. MORTAR SHALL BE TYPE "S" ABOVE GRADE, TYPE "M" BELOW GRADE CONFORMING TO ASTM C270. (MINIMUM 2,000 PSI AT 28 DAYS)
- 3. GROUT SHALL HAVE A MINIMUM COMPRESSIVE STRENGTH OF 3,000 PSI AT 28 DAYS CONFORMING TO ASTM C476
- ALL CELLS CONTAINING REINFORCING STEEL OR EMBEDDED ITEMS, ALL CELLS IN RETAINING WALLS, AND WALLS BELOW GRADE SHALL BE SOLID GROUTED.
- 5. ALL HORIZONTAL REINFORCEMENT SHALL BE PLACED IN BOND BEAM OR LINTEL BEAM UNITS.
- 6. WHEN GROUTING IS STOPPED FOR ONE HOUR OR LONGER, HORIZONTAL CONSTRUCTION JOINTS SHALL BE FORMED BY STOPPING THE GROUT POUR 1-1/2" BELOW TOP OF THE UPPERMOST UNIT.
- 7. ALL BOND BEAM BLOCK SHALL BE "DEEP CUT" UNITS.
- 8. PROVIDE INSPECTION AND CLEAN-OUT HOLES AT BASE OF VERTICAL CELLS HAVING GROUT LIFTS IN EXCESS OF 4'-0" OF HEIGHT.
- 9. ALL GROUT SHALL BE CONSOLIDATED WITH A MECHANICAL VIBRATOR.
- 10. CEMENT SHALL BE AS SPECIFIED FOR CONCRETE.
- 11. REINFORCING BARS SEE NOTES UNDER "REINFORCED CONCRETE NOTES" FOR REQUIREMENTS. REINFORCEMENT SHALL BE PLACED PRIOR TO GROUTING, LAP SPLICES SHALL BE 48 BAR DIAMETERS MINIMUM
- 12. PROVIDE ONE BAR DIAMETER (A MINIMUM OF 1/2") GROUT BETWEEN MAIN REINFORCING AND MASONRY UNITS
- 13. LOW LIFT CONSTRUCTION, MAXIMUM GROUT POUR HEIGHT IS 4 FEET.
- 14. HIGH LIFT GROUTED CONSTRUCTION MAY BE USED IN CONFORMANCE WITH PROJECT SPECIFICATIONS AND SECTION 2104 OF IBC.
- 15. ALL CELLS IN CONCRETE BLOCKS SHALL BE FILLED SOLID WITH GROUT, EXCEPT AS NOTED IN THE DRAWINGS OR SPECIFICATIONS.
- 16. CELLS SHALL BE IN VERTICAL ALIGNMENT, DOWELS IN FOOTINGS SHALL BE SET TO ALIGN WITH CELLS CONTAINING REINFORCING STEEL.
- 17. REFER TO DRAWINGS FOR SURFACE AND HEIGHT OF UNITS, LAYING PATTERN AND JOINT TYPE.
- 18. SAND SHALL BE CLEAN, SHARP AND WELL GRADED, FREE FROM INJURIOUS AMOUNTS OF DUST, LUMPS, SHALE, ALKALI OR ORGANIC MATERIAL.
- 19. ALL MORTAR FIN OBSTRUCTIONS AND DEBRIS SHALL BE CLEANED FROM INSIDE OF CELLS PRIOR TO GROUTING

OWNER'S CERTIFICATION The undersigned is the owner(s) of the property shown hereon, is familiar with this drawing and its contents, and hereby approves same for filing.

Date

Date

Owners Name (Insert Name) Owners Address (Insert Address)

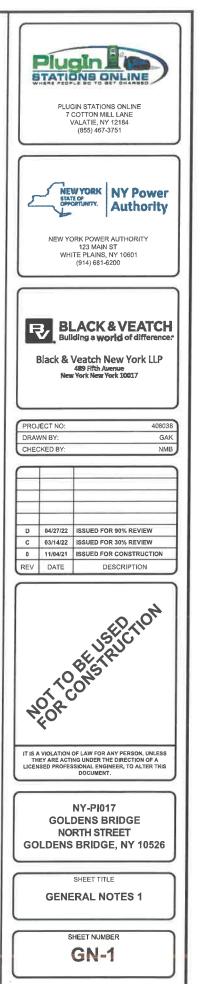

REINFORCED CONCRETE NOTES

CONCRETE SHALL ATTAIN A MINIMUM COMPRESSIVE STRENGTH OF 3000 PSLIN 28 DAYS UNLESS OTHERWISE NOTED' CONTINUOUS INSPECTION IS NOT REQUIRED. SI UMP: 4" MIN / 6"

AIR ENTRAINMENT: 4 1/2% - 7% BY VOLUME

- 2. REINFORCEMENT SHALL BE A NEW BILLET STEEL DEFORMED BARS CONFORMING TO ASTM SPECIFICATION A615 GRADE 60, MAXIMUM COARSE AGGREGATE SIZE SHALL BE 3/4".
- 3. REINFORCEMENT SHALL COMPLY WITH THE LATEST EDITION OF ACI 318 FOR MINIMUM CLEARANCES
- ALL EMBEDDED ITEMS SHALL BE SECURELY HELD IN POSITION PRIOR TO PLACEMENT OF CONCRETE, ALL CONCRETE SHALL BE READY-MIXED IN ACCORDANCE WITH ASTM C94.
- MAINTAIN TEMPERATURE OF CAST IN PLACE CONCRETE BETWEEN 50 DEGREES AND 90 DEGREES FAHRENHEIT
- 6. DO NOT USE RETEMPERED CONCRETE, OR ADD WATER TO READY-MIX CONCRETE AT THE JOB SITE.
- 7. WELDED WIRE FABRIC SHALL CONFORM TO ASTM A185.
- EXCEPT AS DETAILED OR AUTHORIZED, MAKE BARS CONTINUOUS AROUND CORNERS WHERE PERMITTED, SPLICES MADE BY CONTACT LAPS SHALL BE CLASS "B" TENSION LAPS UNLESS NOTED OTHERWISE
- DETAIL BARS IN ACCORDANCE WITH "ACI DETAILING MANUAL", PUBLICATION SP-66 AND " BUILDING CODE REQUIREMENTS FOR REINFORCED CONCRETE", ACI 318.
- 10. PROVIDE ACCESSORIES NECESSARY TO PROPERLY SUPPORT REINFORCING.
- 11. EXPANSION JOINTS SHALL BE CONSTRUCTED AT LOCATIONS WHERE THE CONCRETE PAD ABUTS CONCRETE CURBS, DRIVEWAYS, AND SIMILAR STRUCTURES, AND AS SHOWN ON APPROVED PLANS, EXPANSION JOINTS SHALL BE FORMED WITH ONE-HALF INCH PRE-FABRICATED NON-EXTRUDING FILLER AND SHALL EXTEND THE FULL DEPTH OF THE SLAB.

ANCHORAGE INSTALLATION NOTES

- DRILLING THROUGH EXISTING SLAB REBAR DURING POST-INSTALLED ANCHOR BOLTS INSTALLATION IS NOT PERMITTED.
- 2. POST-INSTALLED ANCHOR BOLT INSTALLATION SHALL BE PERFORMED BY PERSONNEL TRAINED TO INSTALL THE SYSTEM PER THE MANUFACTURER'S PRINTED INSTALLATION INSTRUCTIONS (MPII), AS INCLUDED IN THE ANCHOR PACKAGING.
- EXPANSION AND ADHESIVE ANCHORS SHALL BE INSTALLED PER THE 3. MANUFACTURER'S INSTRUCTIONS USING STANDARD EMBEDMENTS AND EDGE DISTANCES UNLESS NOTED OTHERWISE ON THE DRAWINGS.

CONCRETE SIDEWALK CONSTRUCTION REQUIREMENTS

PLACING AND FINISHING CONCRETE

THE CONTRACTOR SHALL PROVIDE ADEQUATE TOOLS AND EQUIPMENT TO PRODUCE QUALITY WORKMANSHIP IN PLACING AND FINISHING CONCRETE. THE SIDEWALK AND RAMPS SHALL BE FINISHED TO THE TOP OF THE FORMS AND THE SURFACE FINISHED WITH A WOOD OR STEEL FLOAT AND SURFACE TEXTURE SHALL BE A COURSE BROOM FINISH TRANSVERSE TO THE SLOPE OF THE SIDEWALK OR RAMP, NO "PLASTERING" OF THE SURFACE SHALL BE PERMITTED.

- 2. CONTRACTION JOINTS
- THE SIDEWALK SURFACE SHALL BE MARKED OFF INTO NOMINAL SQUARES OF DIMENSION TO THE WIDTH OF THE SIDEWALK WITH A MAXIMUM DISTANCE BETWEEN JOINTS OF SEVEN FEET SAWING JOINTS, THE CONTRACTOR SHALL BEGIN AS SOON AS THE CONCRETE HARDENS SUFFICIENTLY TO PREVENT EXCESSIVE RAVELING ALONG THE SAW CUT AND SHALL FINISH BEFORE CONDITIONS INDUCE UNCONTROLLED CRACKS, REGARDLESS OF THE TIME OR WEATHER.
- 3. EXPANSION JOINTS

EXPANSION JOINTS SHALL BE CONSTRUCTED AT LOCATIONS WHERE THE SIDEWALK ABUTS EXISTING CONCRETE CURBS, DRIVEWAYS, AND SIMILAR STRUCTURES, AND EVERY TWO HUNDRED FIFTY FEET AND AS SHOWN ON APPROVED PLANS, EXPANSION JOINTS SHALL BE FORMED WITH ONE-HALF INCH PREFABRICATED NON-EXTRUDING FILLER AND SHALL EXTEND THE FULL DEPTH OF THE SLAB.

GENERAL SITE WORK NOTES

PART 1 - GENERAL

CLEARING, GRUBBING, STRIPPING, EROSION CONTROL, SURVEY, LAYOUT, SUBGRADE PREPARATION AND FINISH GRADING AS REQUIRED TO COMPLETE THE PROPOSED WORK SHOWN IN THESE PLANS.

1.1 REFERENCES

- A. DOT (STATE DEPARTMENT OF TRANSPORTATION STANDARD SPECIFICATIONS FOR HIGHWAY CONSTRUCTION-CURRENT EDITION)
- B. ASTM (AMERICAN SOCIETY FOR TESTING AND MATERIALS).
- C. OSHA (OCCUPATION SAFETY AND HEALTH ADMINISTRATION)
- 1.2 INSPECTION AND TESTING:
- A GENERAL CONTRACTOR SHALL PERFORM ALL WORK IN CONFORMANCE WITH THE PLANS AND SPECIFICATIONS. PERFORM INSPECTIONS BEFORE CONCEALING WORK WITH FOLLOW-ON ACTIVITIES (BACKFILL, CONCRETE POUR, ETC).
- 1.3 SITE MAINTENANCE AND PROTECTION:
- A. PROVIDE ALL NECESSARY JOB SITE MAINTENANCE FROM COMMENCEMENT OF WORK UNTIL COMPLETION OF THE CONTRACT
- B. AVOID DAMAGE TO THE SITE AND TO EXISTING FACILITIES, STRUCTURES, TREES, AND SHRUBS DESIGNATED TO REMAIN. TAKE PROTECTIVE MEASURES TO PREVENT EXISTING FACILITIES THAT ARE NOT DESIGNATED FOR REMOVAL FROM BEING DAMAGED BY THE WORK
- C. KEEP SITE FREE OF ALL PONDING WATER.
- D. PROVIDE EROSION CONTROL MEASURES IN ACCORDANCE WITH STATE DOT, LOCAL PERMITTING AGENCY AND EPA REQUIREMENTS.
- E. PROVIDE AND MAINTAIN ALL TEMPORARY FENCING, BARRICADES, WARNING SIGNALS AND SIMILAR DEVICES NECESSARY TO PROTECT AGAINST THEFT FROM PROPERTY DURING THE ENTIRE PERIOD OF CONSTRUCTION, REMOVE ALL SUCH DEVICES UPON COMPLETION OF THE WORK
- F. EXISTING UTILITIES: DO NOT INTERRUPT EXISTING UTILITIES SERVING FACILITIES OCCUPIED BY THE OWNER OR OTHERS, EXCEPT WHEN PERMITTED IN WRITING BY THE CONSTRUCTION MANAGER AND THEN ONLY AFTER ACCEPTABLE TEMPORARY UTILITY SERVICES HAVE BEEN PROVIDED.
- G. PROVIDE A MINIMUM 48-HOUR NOTICE TO THE CONSTRUCTION MANAGER AND RECEIVE WRITTEN NOTICE TO PROCEED BEFORE INTERRUPTING ANY UTILITY SERVICE.
- H SOD PLANTED IN THE FALL MUST ESTABLISH ITS BOOTS BEFORE THE FIRST WINTER FROST DETERMINE WHEN THE FIRST FROST USUALLY OCCURS, AND PLANT THE SOD NO LATER THAN ONE MONTH BEFORE THE FIRST FROST. IF THE CONSTRUCTION IS FINISHED LATER THAN ONE MONTH BEFORE THE FIRST FROST, USE STRAW UNTIL SOD CAN BE INSTALLED.

GENERAL SITE WORK NOTES CONT.

PART 2 - PRODUCTS

- 2.1 SUITABLE MATERIAL SUITABLE MATERIAL ARE USED FOR GRADING AND BACKFILL, SUITABLE MATERIALS ARE ON SITE SOILS REMOVED FROM EXCAVATIONS THAT EXCLUDE FROZEN SOIL ROOTS OR ORGANIC MATERIAL, DEBRIS, TRASH, REFUSE, OR PARTICLES SIZE GREATER THAN 3-INCH. SUITABLE SOILS HAVE MOISTURE CONTENTS THAT ALLOW THEM TO BE COMPACTED TO THE SAME DENSITY AS THE NATIVE SOILS
- 2.2 UNSUITABLE MATERIAL SOILS THAT ARE FROZEN, CONTAIN ROOTS OR ORGANIC MATERIAL DEBRIS, TRASH, REFUSE. OR PARTICLES SIZES GREATER THAN 3-INCH. SOILS THAT ARE TOO WET OR TOO DRY TO BE COMPACTED TO THE SAME DENSITY AS THE NATIVE SOILS ARE UNSUITABLE.
- 2.3 GRANULAR BACKFILL SHALL MEET THE FOLLOWING GRADATION

| SIEVE SIZE | TOTAL PERCENT PASSING |
|----------------------|-----------------------|
| 1 1/2 INCH (37.5 MM) | 100 |
| NO. 4 (4.75 MM) | 30 TO 60 |
| NO 200 (0.075 MM) | 3 TO 15 |

- 2.4 GRANULAR BEDDING -- WELL-GRADED SAND MEETING THE GRADATION REQUIREMENT OF ASTM C 33 FINE AGGREGATE.
- 2.5 CONTROLLED LOW STRENGTH MATERIAL (CLSM)- A SELF LEVELING AND SELF COMPACTING CEMENTITIOUS MATERIAL COMPOSED OF SAND, COARSE AGGREGATE, CEMENT, FLY ASH, WATER AND ADMIXTURES, CLSM SHALL BE EXCAVATABLE AND SHALL HAVE A DESIGNED UNCONFINED COMPRESSIVE STRENGTH OF BETWEEN 50 TO 100 PSI.
- 2.6 BACKFILL PRODUCTS MEETING THE REQUIREMENTS OF SUITABLE MATERIAL, GRANULAR BEDDING, GRANULAR BACKFILL OR CLSM.
- 2.7 TOPSOIL SOIL WITH AN ORGANIC CONTENT SUFFICIENT TO ALLOW VEGETATIVE GROWTH.


Janet Andersen, Chair

Kellard Sessions Consulting Town Consulting Engineer

PART 3 - EXECUTION

3.1 GENERAL:

- BEFORE STARTING GENERAL SITE PREPARATION ACTIVITIES, INSTALL EROSION AND SEDIMENT CONTROL MEASURES. THE WORK AREA SHALL BE CONSTRUCTED AND MAINTAINED IN SUCH CONDITION THAT IN THE EVENT OF RAIN THE SITE WILL BE DRAINED AT ALL TIMES.
- BEFORE ALL SURVEY, LAYOUT, STAKING, AND MARKING, ESTABLISH AND MAINTAIN ALL LINES в GRADES, ELEVATIONS AND BENCHMARKS NEEDED FOR EXECUTION OF THE WORK. CONDUCT UTILITY LOCATE IN ACCORDANCE WITH THE ONE-CALL NOTIFICATION
- C. CLEAR AND GRUB THE AREA WITHIN THE LIMITS OF THE SITE. REMOVE TREES, BRUSH, STUMPS, RUBBISH AND OTHER DEBRIS AND VEGETATION RESTING ON OR PROTRUDING THROUGH THE SURFACE OF THE SITE AREA TO BE CLEARED.
- REMOVE THE FOLLOWING MATERIALS TO A DEPTH OF NO LESS THAN 12 INCHES BELOW THE ORIGINAL D GROUND SURFACE: ROOTS, STUMPS, AND OTHER DEBRIS, BRUSH, AND REFUSE EMBEDDED IN OR PROTRUDING THROUGH THE GROUND SURFACE, RAKE, DISK OR PLOW THE AREA TO A DEPTH OF NO LESS THAN 6 INCHES, AND REMOVE TO A DEPTH OF 12 INCHES ALL ROOTS AND OTHER DEBRIS THEREBY EXPOSED
- ન REMOVE TOPSOIL MATERIAL COMPLETELY FROM THE SURFACE UNTIL THE SOIL NO LONGER MEETS THE DEFINITION OF TOPSOIL, AVOID MIXING TOPSOIL WITH SUBSOIL OR OTHER UNDESIRABLE MATERIALS, SUFFICIENT TOPSOL MAY BE STOCKPILED ON SITE FOR USE DURING FINAL SITE GRADING
- EXCEPT WHERE EXCAVATION TO GREATER DEPTH IS INDICATED, FILL DEPRESSIONS RESULTING FROM CLEARING. GRUBBING AND DEMOLITION WORK COMPLETELY WITH SUITABLE MATERIAL.
- G. REMOVE FROM THE SITE AND DISPOSE IN AN AUTHORIZED LANDFILL ALL DEBRIS RESULTING FROM CLEARING AND GRUBBING OPERATIONS, BURNING WILL NOT BE PERMITTED.
- PRIOR TO EXCAVATING, THOROUGHLY EXAMINE THE AREA TO BE EXCAVATED AND/OR TRENCHED TO н. VERIFY THE LOCATIONS OF FEATURES INDICATED ON THE DRAWINGS AND TO ASCERTAIN THE EXISTENCE AND LOCATION OF ANY STRUCTURE, UNDERGROUND STRUCTURE, OR OTHER ITEM NOT SHOWN THAT MIGHT INTERFERE WITH THE PROPOSED CONSTRUCTION, NOTIFY THE CONSTRUCTION MANAGER OF ANY OBSTRUCTIONS THAT WILL PREVENT ACCOMPLISHMENT OF THE WORK AS INDICATED ON THE DRAWINGS.
- SEPARATE AND STOCK PILE ALL EXCAVATED MATERIALS SUITABLE FOR BACKFILL, ALL EXCESS EXCAVATED AND UNSUITABLE MATERIALS SHALL BE DISPOSED OF OFF-SITE IN A LEGAL MANNER.
- REQUIRED TO PREVENT CAVING OR SLOUGHING OF EXCAVATION.
- 3.2 BACKFILL:

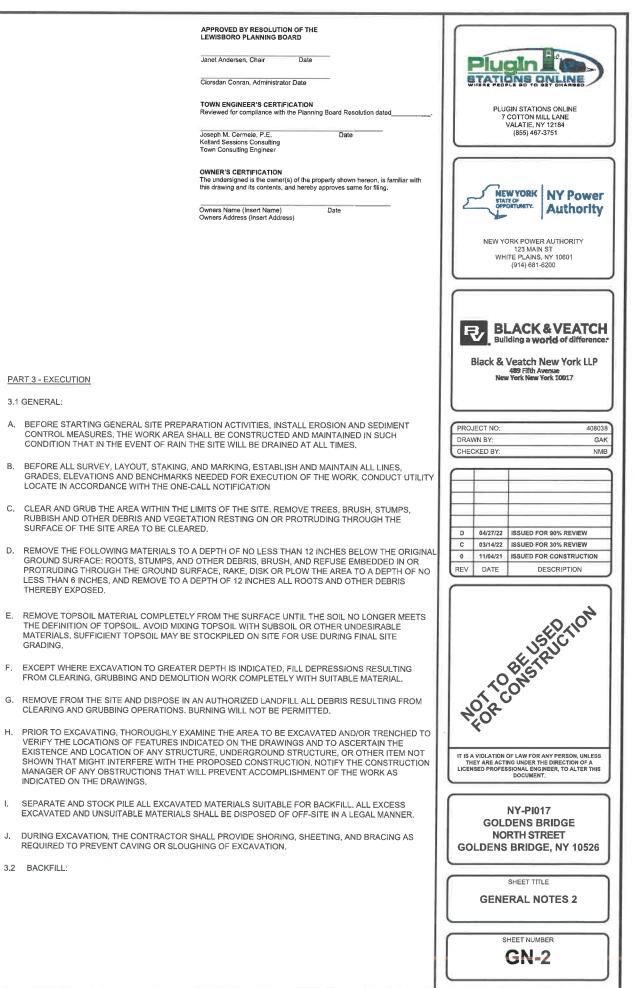

GENERAL SITE WORK NOTES CONT.

- A. AS SOON AS PRACTICAL, AFTER COMPLETING CONSTRUCTION OF THE RELATED STRUCTURE, INCLUDING EXPIRATION OF THE SPECIFIED MINIMUM CURING PERIOD FOR CAST-IN-PLACE CONCRETE BACKFILL THE EXCAVATION WITH APPROVED MATERIAL TO RESTORE THE REQUIRED FINISHED GRADE.
- B. PRIOR TO PLACING BACKFILL AROUND STRUCTURES, ALL FORMS SHALL BE REMOVED AND THE EXCAVATION CLEANED OF ALL TRASH, DEBRIS, AND UNSUITABLE MATERIALS.
- C. DO NOT PLACE FROZEN MATERIAL IN AS BACKFILL.
- D. PLACE BACKFILL MATERIAL OR SELECT GRANULAR BACKFILL MATERIAL WHEN REQUIRED IN UNIFORM HORIZONTAL LAYERS OF NO GREATER THAN 8-INCHES LOOSE THICKNESS AND COMPACT TO THE SAME DENSITY AS NATIVE SOIL. WHERE HAND OPERATED COMPACTORS ARE USED, THE FILL MATERIAL SHALL BE PLACED IN LIFTS NOT TO EXCEED 4 INCHES IN LOOSE DEPTH AND COMPACTED.
- E. WHENEVER TESTING INDICATES THAT THE CONTRACTOR HAS NOT OBTAINED THE SPECIFIED DENSITY, THE SUCCEEDING LAYER SHALL NOT BE PLACED UNTIL THE REQUIREMENTS ARE MET UNLESS OTHERWISE AUTHORIZED BY THE CONSTRUCTION MANAGER. THE CONTRACTOR SHALL TAKE WHATEVER APPROPRIATE ACTION IS NECESSARY, SUCH AS DRYING, ADDING WATER, OR INCREASING THE COMPACTIVE EFFORT TO MEET THE COMPACTION REQUIREMENTS.

3.3 TRENCH EXCAVATION:

- A. UTILITY TRENCHES SHALL BE EXCAVATED TO THE LINES AND GRADES SHOWN ON THE DRAWINGS OR AS DIRECTED BY THE GENERAL CONTRACTOR, PROVIDE SHORING, SHEETING AND BRACING AS REQUIRED TO PREVENT CAVING OR SLOUGHING OF THE TRENCH WALLS.
- B. EXTEND THE TRENCH WIDTH A MINIMUM OF 6 INCHES BEYOND THE OUTSIDE EDGE OF THE OUTERMOST CONDUIT.
- C. WHEN SOFT YIELDING, OR OTHERWISE UNSTABLE SOIL CONDITIONS ARE ENCOUNTERED. EXCAVATE THE REQUIRED TRENCH TO A DEPTH OF NO LESS THAN 12 INCHES BELOW THE REQUIRED ELEVATION, THEN BACKFILL WITH 12" OF GRANULAR BEDDING MATERIAL.
- 3.4 TRENCH BACKFILL:
- A. PROVIDE GRANULAR BEDDING MATERIAL OR FLOWABLE FILL IN ACCORDANCE WITH THE DRAWINGS AND THE UTILITY REQUIREMENTS.
- B. NOTIFY THE GENERAL CONTRACTOR 24 HOURS IN ADVANCE OF BACKFILLING.
- CONDUCT UTILITY CHECK TESTS BEFORE BACKFILLING. BACKFILL AND COMPACT TRENCH BEFORE ACCEPTANCE TESTING.
- D. PLACE GRANULAR TRENCH BACKFILL UNIFORMLY ON BOTH SIDES OF THE CONDUITS IN 6-INCH UNCOMPACTED LIFTS UNTIL 12 INCHES OVER THE CONDUITS, SOLIDLY RAM AND TAMP BACKFILL INTO SPACE AROUND CONDUITS
- E. PROTECT CONDUIT FROM LATERAL MOVEMENT, IMPACT DAMAGE, OR UNBALANCED LOADING.
- ABOVE THE CONDUIT EMBEDMENT ZONE, PLACE AND COMPACT SATISFACTORY BACKFILL MATERIAL IN 8-INCH MAXIMUM LOOSE THICKNESS LIFTS TO RESTORE THE REQUIRED FINISHED SURFACE GRADE.
- G. COMPACT FINAL TRENCH BACKFILL TO A DENSITY EQUAL TO OR GREATER THAN THAT OF THE EXISTING UNDISTURBED MATERIAL IMMEDIATELY ADJACENT TO THE TRENCH
- 3.5 FINISH GRADING:
- PERFORM ALL GRADING TO PROVIDE POSITIVE DRAINAGE AWAY FROM STRUCTURES AND SMOOTH. EVEN SURFACE DRAINAGE OF THE ENTIRE AREA WITHIN THE LIMITS OF CONSTRUCTION. GRADING SHALL BE COMPATIBLE WITH ALL SURROUNDING TOPOGRAPHY AND STRUCTURES.
- UTILIZE SATISFACTORY FILL MATERIAL RESULTING FROM THE EXCAVATION WORK IN THE CONSTRUCTION OF FILLS, EMBANKMENTS AND FOR REPLACEMENT OF REMOVED UNSUITABLE MATERIALS.
- REPAIR ALL ACCESS ROADS AND SURROUNDING AREAS USED DURING THE COURSE OF THIS WORK TO THEIR ORIGINAL CONDITION,

3.6 ASPHALT PAVING ROAD:

NEW MEXICO STANDARD SPECIFICATIONS

DIVISION 400 - NMDOT ASPHALT

- CONTRACTOR RESPONSIBLE FOR RE-STRIPING AND APPLYING SEALCOATING, UNLESS OTHERWISE Α. SPECIFIED.
- B. ALL ELECTRIC VEHICLE CHARGING STALLS WITH AN ASPHALT SURFACE SHALL BE SEALCOATED.

ELECTRICAL NOTES

- THE ELECTRICAL CONTRACTOR SHALL SUPPLY AND INSTALL ANY/ALL ELECTRICAL WORK INDICATED. ANY/ALL CONSTRUCTION SHALL BE IN ACCORDANCE WITH DRAWINGS AND ANY/ALL APPLICABLE SPECIFICATIONS. IF ANY PROBLEMS ARE ENCOUNTERED BY COMPLYING WITH THESE REQUIREMENTS, CONTRACTOR SHALL NOTIFY 'CONSTRUCTION MANAGER' AS SOON AS POSSIBLE, AFTER THE DISCOVERY OF THE PROBLEMS, AND SHALL NOT PROCEED WITH THAT PORTION OF WORK, UNTIL THE 'CONSTRUCTION MANAGER' HAS DIRECTED THE CORRECTIVE ACTIONS TO BE TAKEN.
- 2. THE ELECTRICAL CONTRACTOR SHALL VISIT THE JOB SITE AND FAMILIARIZE THEMSELVES WITH ANY/ALL CONDITIONS AFFECTING ELECTRICAL AND COMMUNICATION INSTALLATION AND MAKE PROVISIONS AS TO THE COST THEREOF. THE CONDITION OF EXISTING ELECTRICAL EQUIP., LIGHT FIXTURES, ETC., THAT ARE PART OF THE FINAL SYSTEM, SHALL BE VERIFIED BY THE CONTRACTOR, PRIOR TO THE SUBMITTAL OF HIS BID. FAILURE TO COMPLY WITH THIS PARAGRAPH WILL IN NO WAY RELIEVE CONTRACTOR OF PERFORMING ALL WORK NECESSARY FOR A COMPLETE AND WORKING SYSTEM.
- 3 ALL WORK SHALL BE PERFORMED IN ACCORDANCE WITH THE LATEST EDITION OF THE NEC AND ALL CODES AND LOCAL ORDINANCES OF THE LOCAL POWER COMPANIES HAVING JURISDICTION AND SHALL INCLUDE BUT NOT BE LIMITED TO:

A. UL - UNDERWRITERS LABORATORIES B. NEC - NATIONAL ELECTRICAL CODE C. NEMA - NATIONAL ELECTRICAL MANUFACTURERS ASSOC D. OSHA - OCCUPATIONAL SAFETY AND HEALTH ACT E. SBC - STANDARD BUILDING CODE F. NFPA - NATIONAL FIRE PROTECTION ASSOCIATION

- 4. DO NOT SCALE ELECTRICAL DRAWINGS, REFER TO SITE PLANS AND ELEVATIONS FOR EXACT LOCATIONS OF ALL EQUIPMENT, BUT CONFIRM WITH 'CONSTRUCTION MANAGER' ANY SIZES AND LOCATIONS WHEN NEEDED.
- EXISTING SERVICES: THE CONTRACTOR SHALL NOT INTERRUPT EXISTING SERVICES WITHOUT 5. WRITTEN PERMISSION OF THE OWNER
- THE CONTRACTOR SHALL PAY FOR ANY/ALL PERMITS, FEES, INSPECTIONS AND TESTING. THE 6. CONTRACTOR IS TO OBTAIN PERMITS AND APPROVED SUBMITTALS PRIOR TO THE WORK BEGINNING OR ORDERING THE FOURPMENT
- THE TERM "PROVIDE" USED IN CONSTRUCTION DOCUMENTS AND SPECIFICATIONS, INDICATES 7. THAT THE CONTRACTOR SHALL FURNISH AND INSTALL
- THE CONTRACTOR SHALL CONFIRM WITH LOCAL UTILITY COMPANY ANY/ALL REQUIREMENTS 8. SUCH AS THE: LUG SIZE RESTRICTIONS, CONDUIT ENTRY, SIZE OF TRANSFORMERS, SCHEDULED DOWNTIME FOR THE OWNERS' CONFIRMATION, ETC. ANY/ALL CONFLICTS SHALL BE BROUGHT TO THE ATTENTION OF THE CONSTRUCTION MANAGER, PRIOR TO BEGINNING ANY WORK
- 9. CONDUCTORS: CONTRACTOR SHALL USE 98% CONDUCTIVITY COPPER OR ALUMINUM WITH TYPE (THWN-2) INSULATION, 600 VOLT, COLOR CODED UNLESS SPECIFIED DIFFERENTLY ON DRAWINGS.
- 10. ALL WIRING AND CONDUIT INSTALLATIONS SHALL BE COMPLIANT WITH NEC ARTICLE 300.5 AND 310.10 AND TO FOLLOW MANUFACTURER'S INSTRUCTIONS AND RECOMMENDATIONS.
- 11. OUTLET BOXES SHALL BE PRESSED STEEL IN DRY LOCATIONS, CAST ALLOY WITH THREADED HUBS IN WET/DAMP LOCATIONS AND SPECIAL ENCLOSURES FOR OTHER CLASSIFIED AREAS.
- 12. IT IS NOT THE INTENT OF THESE PLANS TO SHOW EVERY MINOR DETAIL OF THE CONSTRUCTION. CONTRACTOR IS EXPECTED TO FURNISH AND INSTALL ALL ITEMS FOR A COMPLETE ELECTRICAL SYSTEM AND PROVIDE ALL REQUIREMENTS FOR THE EQUIPMENT TO BE PLACED IN PROPER WORKING ORDER. CONTRACTOR IS TO PROVIDE ALL ELECTRICAL EQUIPMENT UNLESS OTHERWISE DIRECTED.
- 13. ALL WORK SHALL BE PERFORMED BY A LICENSED ELECTRICAL CONTRACTOR IN A FIRST CLASS, WORKMANLIKE MANNER. THE COMPLETED SYSTEM SHALL BE FULLY OPERATIONAL AND SUBJECT TO REGULATORY INSPECTION AND APPROVAL BY CONSTRUCTION MANAGER
- 14. ALL WORK SHALL BE COORDINATED WITH OTHER TRADES TO AVOID INTERFERENCE WITH THE PROGRESS OF CONSTRUCTION.
- 15. CONTRACTOR SHALL GUARANTEE ANY/ALL MATERIALS AND WORK FREE FROM DEFECTS FOR A PERIOD OF NOT LESS THAN ONE YEAR FROM DATE OF ACCEPTANCE.
- 16. THE CORRECTION OF ANY DEFECTS SHALL BE COMPLETED WITHOUT ANY ADDITIONAL CHARGE AND SHALL INCLUDE THE REPLACEMENT OR THE REPAIR OF ANY OTHER PHASE OF THE INSTALLATION, WHICH MAY HAVE BEEN DAMAGED THEREIN
- 17. ADEQUATE AND REQUIRED LIABILITY INSURANCE SHALL BE PROVIDED FOR PROTECTION AGAINST PUBLIC LOSS AND ANY/ALL PROPERTY DAMAGE FOR THE DURATION OF WORK.
- 18. PROVIDE AND INSTALL CONDUIT, CONDUCTORS, PULL WIRES, BOXES, COVER PLATES AND DEVICES FOR ALL OUTLETS AS INDICATED.
- 19. TRENCHING AND BACKFILL: THE CONTRACTOR SHALL PROVIDE FOR ALL UNDERGROUND INSTALLED CONDUIT AND/OR CABLES INCLUDING EXCAVATION AND BACKFILLING AND COMPACTION. REFER TO GENERAL SITE WORK NOTES.
- 20. MATERIALS, PRODUCTS AND EQUIPMENT, INCLUDING ALL COMPONENTS THEREOF, SHALL BE NEW AND SHALL APPEAR ON THE LIST OF U.L. APPROVED ITEMS AND SHALL MEET OR EXCEED THE REQUIREMENTS OF THE NEC, NEMA AND IEEE.
- 21. CONTRACTOR SHALL SUBMIT SHOP DRAWINGS OR MANUFACTURES CATALOG INFORMATION OF ANY/ALL LIGHTING FIXTURES, SWITCHES AND ALL OTHER ELECTRICAL ITEMS FOR APPROVAL BY THE CONSTRUCTION MANAGER PRIOR TO INSTALLATION.
- 22. ANY CUTTING OR PATCHING DEEMED NECESSARY FOR ELECTRICAL WORK IS THE ELECTRICAL

Janet Andersen, Chair

Ciorsdan Conran, Administrator Date

TOWN ENGINEER'S CERTIFICATION wed for compliance with the Planning Board Resolution dated

Kellard Sessi OWNER'S CERTIFICATION

Owners Name (Insert Name) Owners Address (Insert Address)

ELECTRICAL NOTES CONT.

CONTRACTORS RESPONSIBILITY AND SHALL BE INCLUDED IN THE COST FOR WORK AND PERFORMED TO THE SATISFACTION OF THE 'CONSTRUCTION MANAGER' UPON FINAL ACCEPTANCE.

- 23. THE ELECTRICAL CONTRACTOR SHALL LABEL ALL PANELS WITH ONLY TYPEWRITTEN DIRECTORIES.
- 24. DISCONNECT SWITCHES SHALL BE H.P. RATED HEAVY-DUTY, QUICK-MAKE AND QUICK-BREAK ENCLOSURES, AS REQUIRED BY EXPOSURE TYPE.
- 25. ALL CONNECTIONS EXCEPT THE EV CHARGE CABLE TERMINATION IN THE CHARGE POST SHALL BE MADE WITH A PROTECTIVE COATING OF AN ANTI-OXIDE COMPOUND SUCH AS "NOALOX" BY IDEAL INDUSTRIAL INC., COAT ALL WIRE SURFACES BEFORE CONNECTING, EXPOSED ALUMINUM & COPPER SURFACES, INCLUDING GROUND BARS, SHALL BE TREATED - NO SUBSTITUTIONS.
- 26. ALL EXTERIOR AND INTERIOR ABOVE GROUND CONDUIT SHALL BE RIGID UNLESS SPECIFIED OTHERWISE. ALL BURIED CONDUITS SHALL BE SCH 40 PVC UNLESS SPECIFIED OTHERWISE.
- 27. RACEWAYS: CONDUIT SHALL BE SCHEDULE 40 PVC, MEETING OR EXCEEDING NEMA TC2 2013. THE CONTRACTOR SHALL PLUG AND CAP EACH END OF SPARE AND EMPTY CONDUITS AND PROVIDE TWO SEPARATE PULL STRINGS - 200 LBS TEST POLYETHYLENE CORD, ALL CONDUIT BENDS SHALL NOT BE LESS THAN SHOWN IN TABLE 2 CHAPTER 9 OF THE NEC. RGS CONDUITS WHEN SPECIFIED, SHALL MEET UL-6 FOR GALVANIZED STEEL. ALL FITTINGS SHALL BE SUITABLE FOR USE WITH THREADED RIGID CONDUIT, COAT ALL THREADS WITH 'BRITE ZINC' OR 'GOLD GALV'

28. SUPPORT OF ALL ELECTRICAL WORK SHALL BE AS REQUIRED BY NEC.

- 29. CONNECTORS FOR POWER CONDUCTORS: CONTRACTOR SHALL USE PRESSURE TYPE INSULATED TWIST-ON CONNECTORS FOR NO. 10 AWG AND SMALLER. USE SOLDERLESS MECHANICAL TERMINAL LUGS FOR NO. 8 AWG AND LARGER.
- 30. THE CONTRACTOR SHALL PLACE TWO LENGTHS OF WARNING TAPE AT A DEPTH OF 12" BELOW GROUND AND DIRECTLY ABOVE ELECTRICAL SERVICE CONDUITS, CAUTION TAPE TO READ "CAUTION BURIED ELECTRIC".
- 31. WHEN DIRECTIONAL BORING IS REQUIRED, CONTRACTOR SHALL INSTALL A LOOSE TONING WIRE WITHIN INSTALLED CONDUIT TO ALLOW FOR IDENTIFICATION OF UNDERGROUND CONDUITS.
- 32. ALL BOLTS SHALL BE STAINLESS STEEL,
- 33. ALL MATERIALS AND EQUIPMENT SUPPLIED AND INSTALLED BY THE CONTRACTOR SHOULD BE NEW AND UNUSED.

GROUNDING NOTES

- STAINLESS STEEL INCLUDING LOCK WASHERS, COAT ALL SURFACES WITH AN ANTI-OXIDANT COMPOUND BEFORE MATING
- 2. FOR GROUND BOND TO STEEL ONLY: INSERT A CADMIUM FLAT WASHER BETWEEN LUG AND STEEL COAT ALL SURFACES WITH AN ANTI-OXIDANT COMPOUND BEFORE MATING.
- 3. ENSURE THE WIRE INSULATION TERMINATION IS WITHIN 1/8" OF THE BARREL (NO SHINERS).
- 4. ALL BELOW GRADE BONDS TO BE EXOTHERMIC WELDS OR IRREVERSIBLE COMPRESSION TYPE CONNECTIONS LISTED FOR USE IN THE APPLICATION WHICH THEY ARE INSTALLED.

FIBER OPTIC NOTES

USE CABLE WITH THE FOLLOWING MINIMUM PROPERTIES:

- 1. HIGH TENSILE STRENGTH >150 LB
 - 2. TIGHT BUFFERED
- 3. INDOOR / OUTDOOR UV AND MOISTURE RESISTANT "RISER" CABLE 4. CONNECTOR TYPE: ST-ST
- 5. FIBER TYPE: MULTI-MODE 6-FIBER (3 PAIR) 62.5UM. 6 CONNECTORS ON BOTH ENDS. 6. JACKET: INDOOR/OUTDOOR RISER, BLACK
- 7. BREAKOUT: SIDE A: INNER END 24 INCHES WITH 2MM FURCATION
- 8. WITH PULLING EYE ON SIDE B (OUTER END) AND SPOOL REEL

APPROVED BY RESOLUTION OF THE LEWISBORO PLANNING BOARD

Joseph M, Cermele, P.E ons Consulting Town Consulting Engine


The undersigned is the owner(s) of the property shown hereon, is familiar with this drawing and its contents, and hereby approves same for filing

Date


Date

1. ALL HARDWARE SHALL BE STAINLESS STEEL 3/8" DIAMETER OR LARGER, ALL HARDWARE 18-8

SIDE B: OUTER END - 24 INCHES - 2MM FURCATION - STAGGERED EVERY 1"

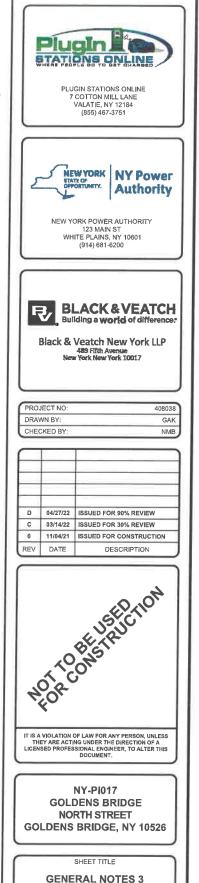


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| GINEER'S CERTIFICATION or compliance with the Planning Board Resolution dated | PLUGIN STATIONS ONLINE |
| Cermele, P.E. Date | 7 COTTON MILL LANE VALATIE, NY 12184 (855) 467-3751 |
| sions Consulting ulting Engineer | |
| CERTIFICATION igned is the owner(s) of the property shown hereon, is familiar with | |
| and its contents, and hereby approves same for filing. | NEW YORK NY Power |
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| * | LICENSED PROFESSIONAL ENGINEER, TO ALTER THIS DOCUMENT. |
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Janet Andersen, Chair

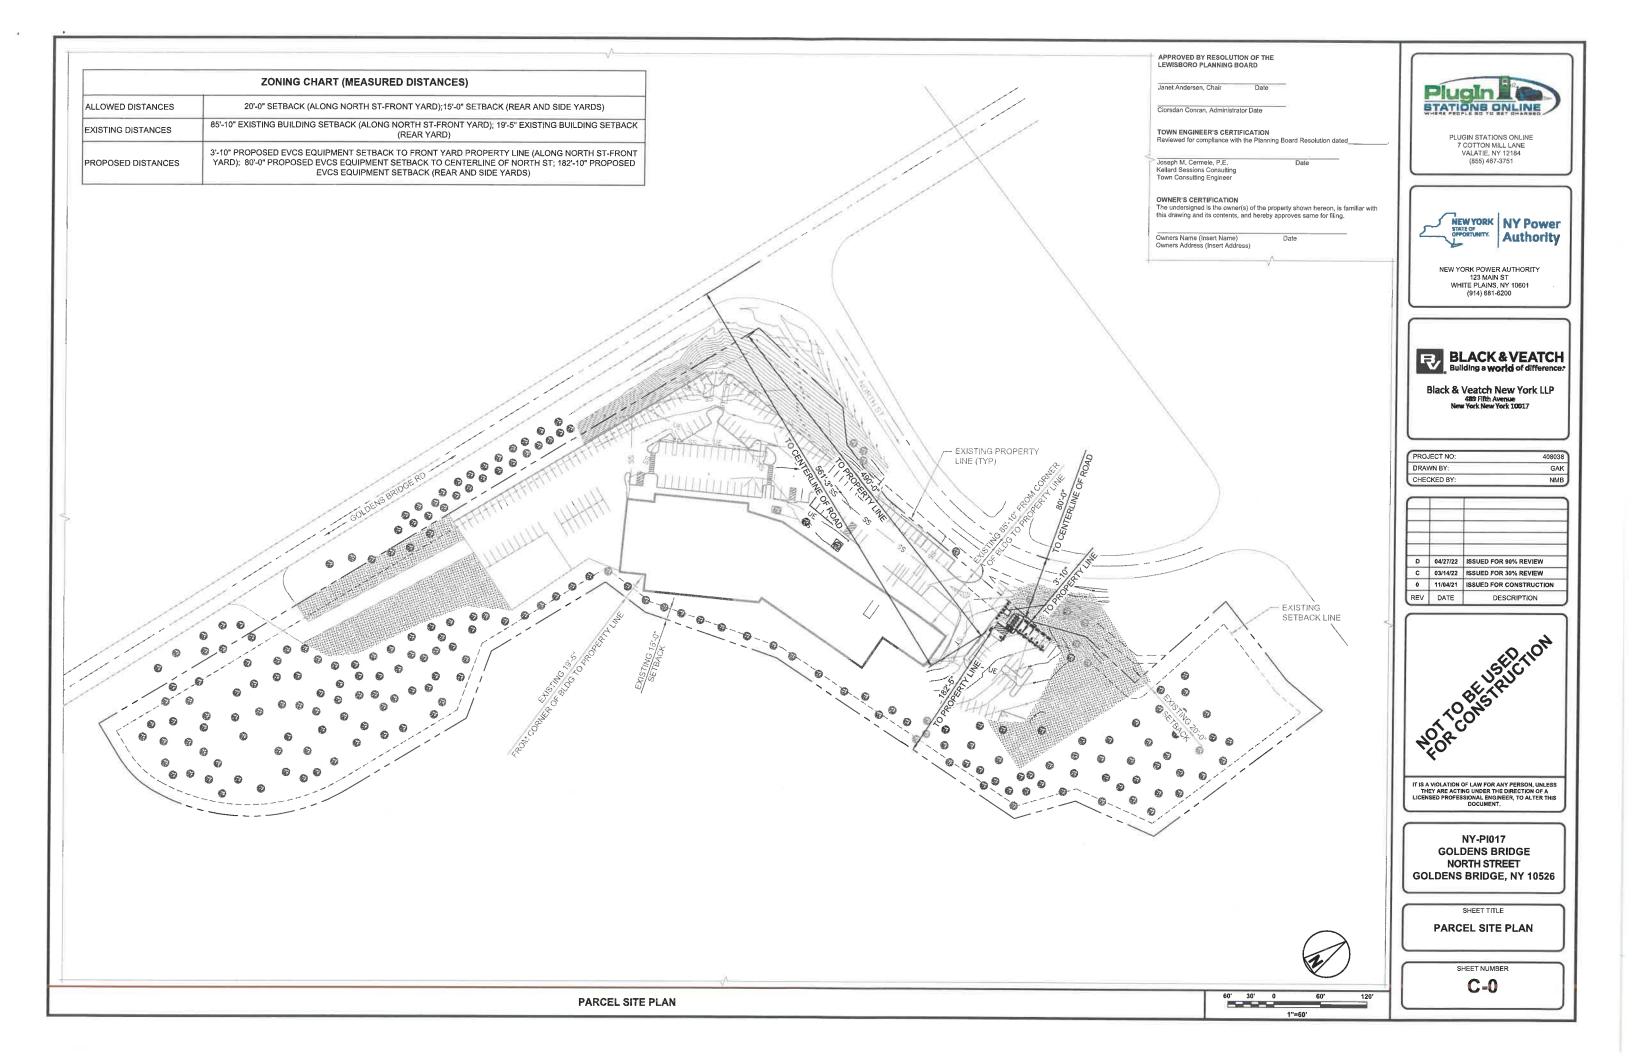Ciorsdan Conran, Administrator Date

Joseph M. Cermele, P.E. Kellard Sessions Consulting Town Consulting Engineer

Owners Name (Insert Name) Owners Address (Insert Address)

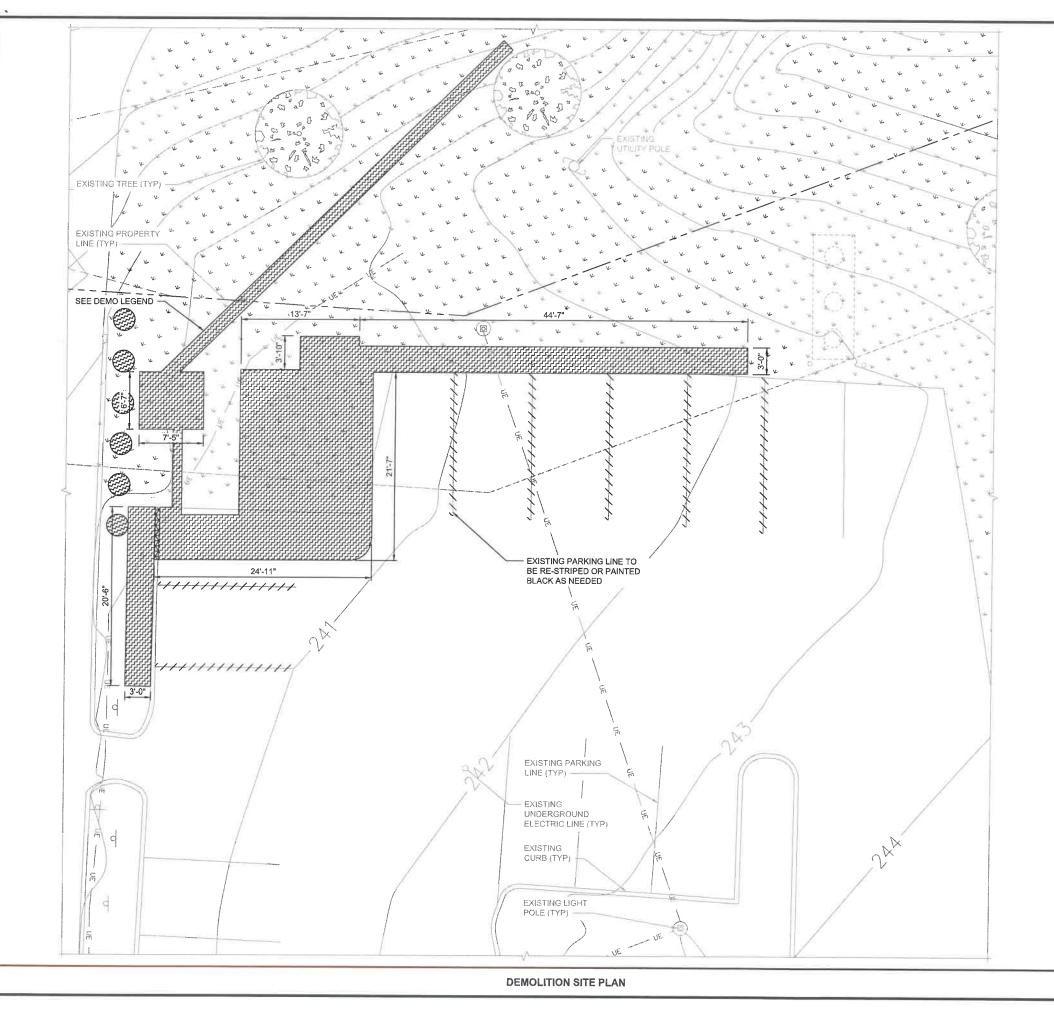NOTES

1. THE CONTRACTOR SHALL RETURN SIDEWALKS, LANDSCAPING, PLANTERS, IRRIGATION SYSTEMS, AND ANY OTHER FACILITIES DISTURBED BY THE WORK TO THE SAME OR BETTER CONDITION THAN EXISTED PRIOR TO THE COMMENCEMENT OF THE WORK.

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3/16"=1'-0"

APPROVED BY RESOLUTION OF THE LEWISBORO PLANNING BOARD

Date

TOWN ENGINEER'S CERTIFICATION

Reviewed for compliance with the Planning Board Resolution dated

OWNER'S CERTIFICATION


The undersigned is the owner(s) of the property shown hereon, is familiar with this drawing and its contents, and hereby approves same for filing.


Date


Date


2. TREES HAVE BEEN MARKED BY NYSEG FOR REMOVAL OR TRIMMING. BRUSH TO BE TRIMMED AS NEEDED TO FACILITATE CONSTRUCTION.


| DEMO LEGEND | |
|-------------|-------------|
| XXXX | CURB |
| हररस | LANDSCAPING |

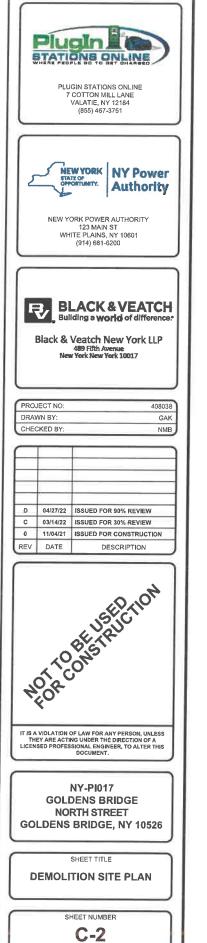

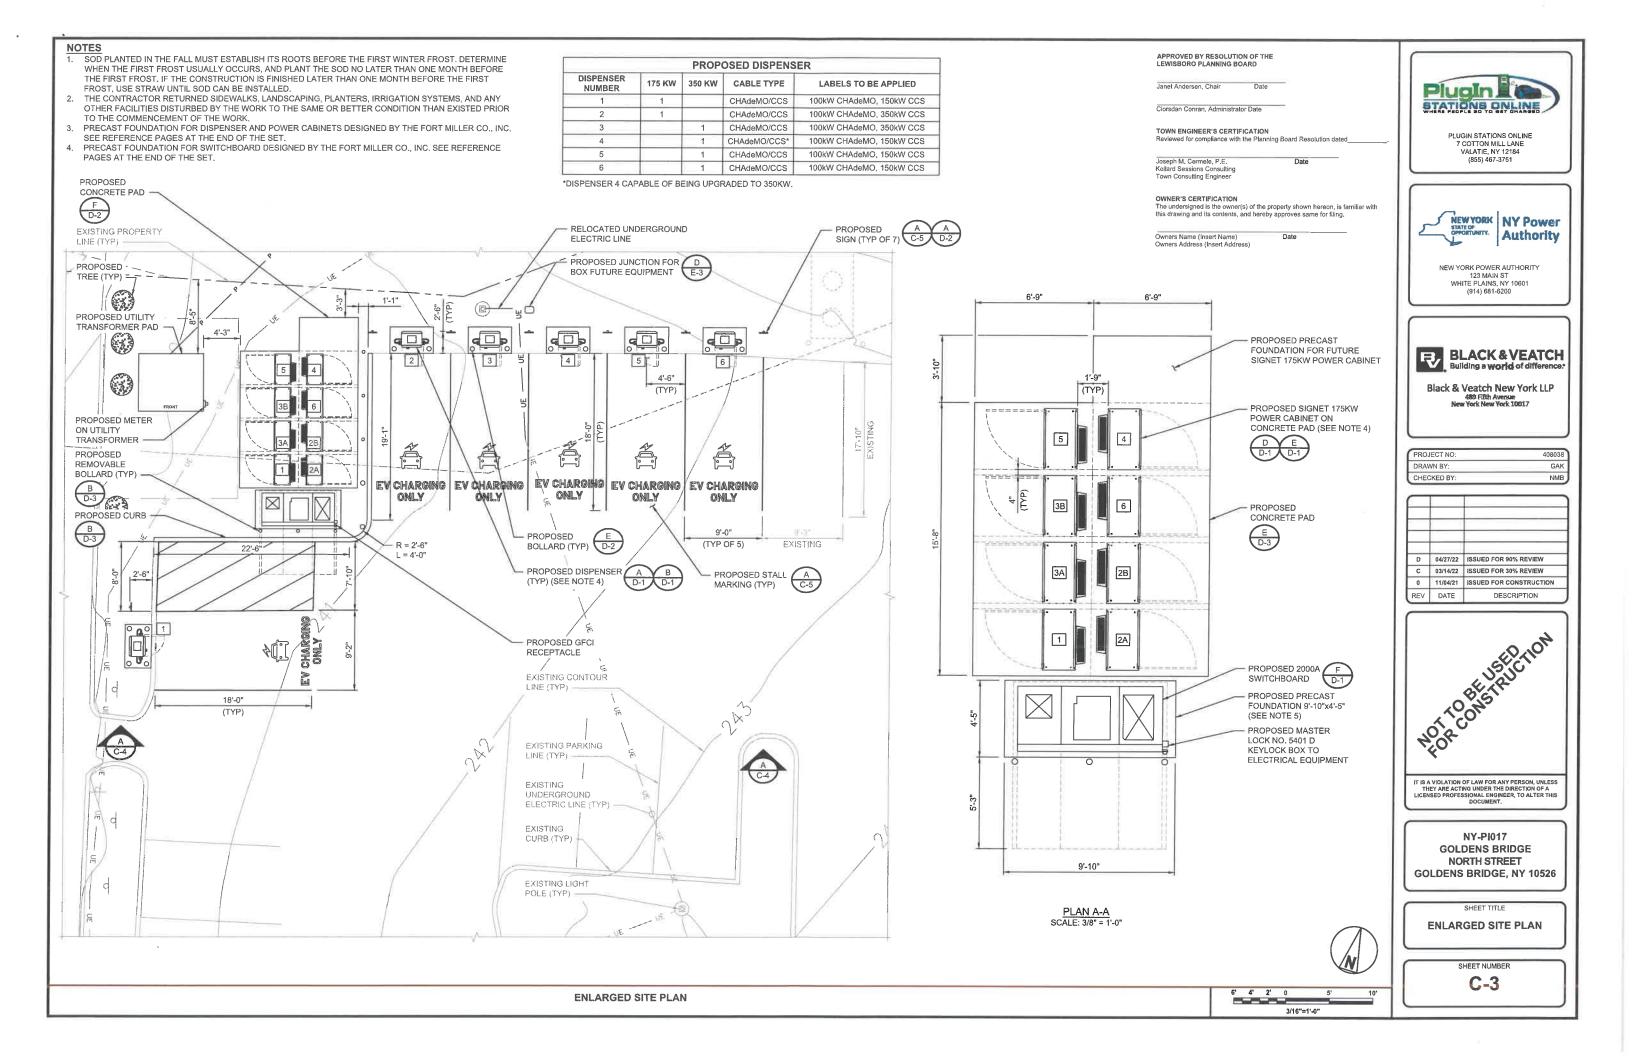

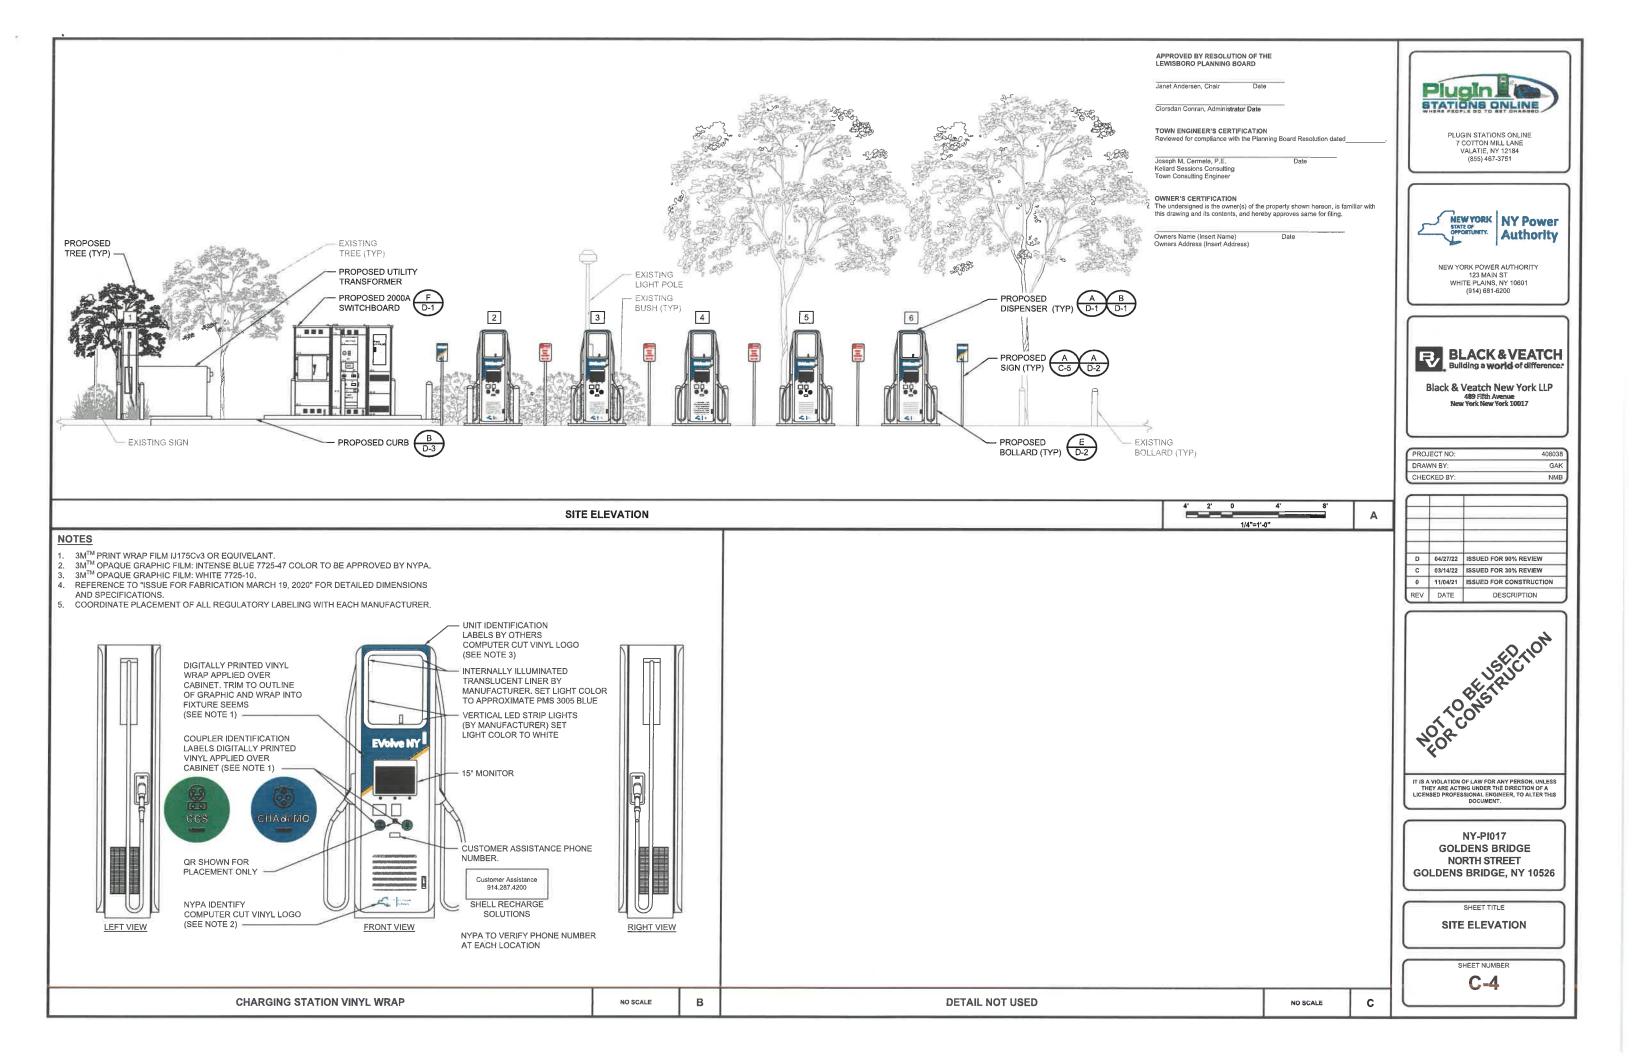

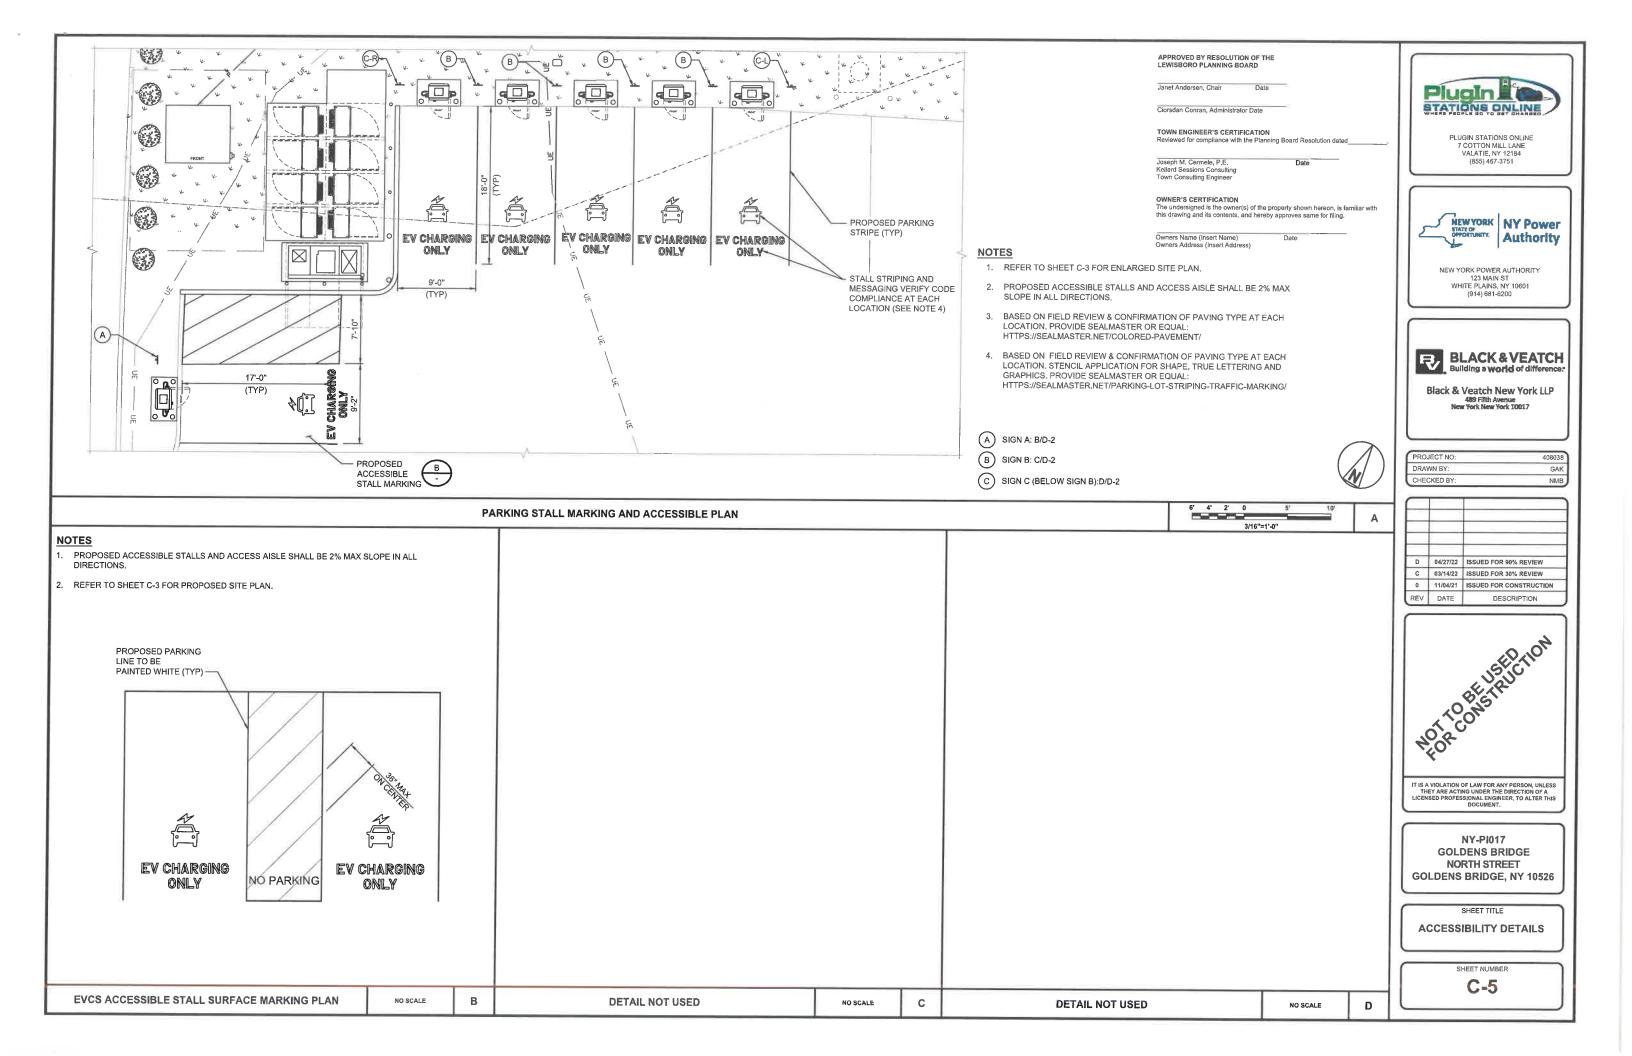

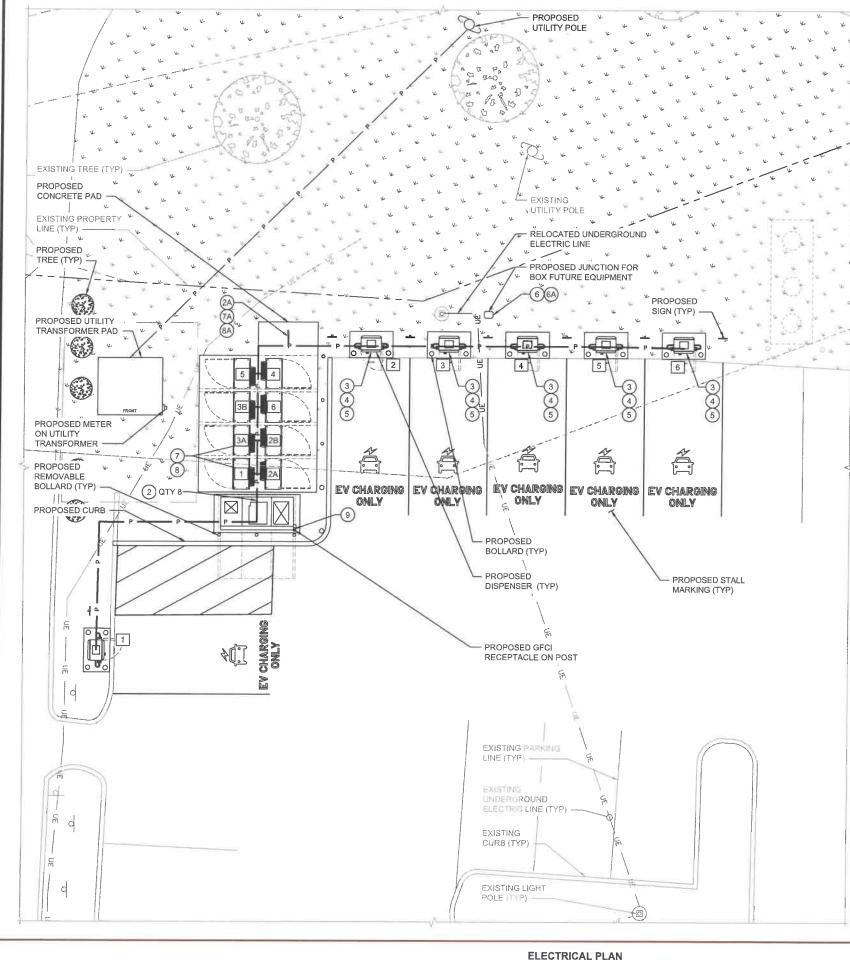

Janet Andersen, Chair Date

Ciorsdan Conran, Administrator Date

TOWN ENGINEER'S CERTIFICATION Reviewed for compliance with the Planning Board Resolution date

Kellard Sessions Consulting Town Consulting Engineer

OWNER'S CERTIFICATION The undersigned is the owner(s) of the property shown hereon, is familiar with this drawing and its contents, and hereby approves same for filing.

Date

Owners Name (Insert Name) Owners Address (Insert Address)

| DC CHARGING POST LENGTHS | | | |
|--------------------------|-----------|-----------------------|-----------------------------|
| POWER UNIT | DISPENSER | LINEAR LENGTH (FT) | ***ESTIMATED LENGTH (FT) |
| 1 | 1 | 40 | 62 |
| 2A | 2 | 30 | 52 |
| 2B | 2 | 26 | 48 |
| 3A | 3 | 35 | 57 |
| 3B | 3 | 31 | 53 |
| 4 | 4 | 36 | 58 |
| 5 | 5 | 45 | 67 |
| 6 | 6 | 58 | 80 |

(SEE SHEET E-2 FOR WIRE CONFIGURATION)

| POWER UNIT LENGTHS | | |
|--|---|--|
| LINEAR LENGTH SWBD TO POWER UNIT | **ESTIMATED LENGTH | |
| 5 | 21 | |
| 5 | 21 | |
| 9 | 25 | |
| 9 | 25 | |
| 13 | 29 | |
| 17 | 33 | |
| 17 | 33 | |
| 13 | 29 | |
| | LINEAR LENGTH SWBD TO POWER UNIT 5 5 9 9 9 13 17 17 17 | |

CHA

(SEE SHEET E-2 FOR WIRE CONFIGURATION)

NOTES

** AC CONDUCTOR: 16 FEET IS ADDED TO HORIZONTAL RUN LENGTH TO ACCOUNT FOR BURIED DEPTH

*** DC CONDUCTORS: 22 FEET IS ADDED TO HORIZONTAL RUN LENGTH TO ACCOUNT FOR BURIED DEPTH

- CONDUIT ROUTING IS DIAGRAMMATICALLY SHOWN ON PLANS AND ARE ONLY APPROXIMATIONS. THE EXACT LOCATION AND ROUTING PATHS SHALL BE FIELD VERIFIED AND INSTALLED PER JURISDICTIONAL REQUIREMENTS.
- 2. ALL ELECTRICAL WORK AND RELATED ACTIVITIES PERFORMED ONSITE SHALL BE DONE IN ACCORDANCE WITH NATIONAL ELECTRICAL CODE (NEC) STANDARDS BEING ENFORCED BY ALL APPLICABLE JURISDICTIONAL REQUIREMENTS AT TIME OF CONSTRUCTION.
- UTILITY EQUIPMENT INSTALLATIONS AND PREP WORK SHALL BE COORDINATED WITH THE APPROPRIATE 3. UTILITY ENGINEER TO ENSURE ACCURACY OF INSTALLATIONS.
- 4. REFER TO CONDUIT AND WIRE SCHEDULE ON E-2 FOR CONDUIT AND WIRE REQUIREMENTS.
- 5. CONDUIT PATHS ARE NOT INTENDED TO TURN THROUGH THE PARKING LOT.
- 6. PROPOSED UTILITY TRANSFORMER WILL REQUIRE GROUND WIRES #2 STR. BARE COPPER BURIED 18" DEEP. 2 RINGS SPACED 12" AND 30" FROM VAULT.
- PROPOSED 36" DEEP UTILITY TRENCH FROM THE PROPOSD UTILITY POLE TO THE TRANSFORMER 7. WITH 6" OF SAND BELOW AND ABOVE THE 4" CONDUITS

APPROVED BY RESOLUTION OF THE LEWISBORO PLANNING BOARD

Joseph M. Cermele, P.E

| | | 22 | |
|-------------------|--------|--------|--|
| ROPOSED DISPENSER | | | |
| RGE POST | 175 KW | 350 KW | |
| 1 | 1 | | |
| 2 | | 1 | |
| 3 | | 1 | |
| 4 | 1 | | |
| 5 | 1 | | |
| 6 | 1 | | |


3/16"=1'-0"

10


6' 4' 2' 0


Pluain STATIONS ONLINE PLUGIN STATIONS ONLINE 7 COTTON MILL LANE VALATIE, NY 12184 (855) 467-3751 NEW YORK NY Power Authority NEW YORK POWER AUTHORITY 123 MAIN ST WHITE PLAINS, NY 10601 (914) 681-6200 Building a world of diffe Black & Veatch New York LLP 489 Fifth Avenue New York New York 10017 PROJECT NO 40803 DRAWN BY: GAL CHECKED BY NMB D 04/27/22 ISSUED FOR 90% REVIEW C 03/14/22 ISSUED FOR 30% REVIEW 0 11/04/21 ISSUED FOR CONSTRUCTION REV DATE DESCRIPTION TZCONSTRUCTION NUR IT IS A VIOLATION OF LAW FOR ANY PERSON, UNLESS THEY ARE ACTING UNDER THE DIRECTION OF A LICENSED PROFESSIONAL ENGINEER, TO ALTER THIS DOCUMENT. NY-PI017 GOLDENS BRIDGE NORTH STREET **GOLDENS BRIDGE, NY 10526** SHEET TITLE ELECTRICAL PLAN SHEET NUMBER E-1


APPROVED BY RESOLUTION OF THE LEWISBORO PLANNING BOARD Janet Andersen, Chair Date Pluain 🗎 STATIONS ONLINE Clorsdan Conran, Administrator Date TOWN ENGINEER'S CERTIFICATION PLUGIN STATIONS ONLINE Reviewed for compliance with the Planning Board Resolution dated 7 COTTON MILL LANE VALATIE, NY 12184 Joseph M, Cermele, P.E. Date (855) 467-3751 Town Consulting Enginee OWNER'S CERTIFICATION The undersigned is the owner(s) of the property shown hereon, is familiar with this drawing and its contents, and hereby approves same for filing. NEWYORK NY Power Authority Owners Name (Insert Name) Owners Address (Insert Address) NEW YORK POWER AUTHORITY 123 MAIN ST WHITE PLAINS, NY 10601 (914) 681-6200 198 19 <u>8</u> 30/ 1 P 15/ 1P **BLACK & VEATCH** Ŗ Building a world of differe Black & Veatch New York LLP 489 Fifth Avenue New York New York 10017 PROJECT NO 40803 PROPOSED GFCI RECEPTACLE IN DRAWN BY: GAK WEATHERPROOF ENCLOSURE CHECKED BY NMB SIGNET CONDUIT AND WIRING SCHEDULE CONFIGURATION TO (3) 1/0 AWG 15KV EPR WITH CONTENTRIC NEUTRALS IN (1) OF THE (2) 4" CONDUITS D 04/27/22 ISSUED FOR 90% REVIEW (3) 600 MCM CU (THWN-2) + C 03/14/22 ISSUED FOR 30% REVIEW (1) 350 MCM CU NEUT (THWN-2) 0 11/04/21 ISSUED FOR CONSTRUCTION IN EACH OF (5) 4" CONDUITS REV DATE DESCRIPTION (3) 350 MCM CU (THWN-2) + (1) #2 AWG CU (THWN-2) EGC NOTE CONSTRUCTION IN (1) 3" CONDUIT (1) 3" CONDUIT (2) 262.6 MCM CU (HDFPC-DLO) 2KV + (1) #2 AWG CU (HDFPC-DLO) EGC IN EACH OF THE (2) 3" CONDUITS (1) 4 STRAND 62.5 BUFFERED I/O MM FIBER (ST CONN) (2) TWISTED PAIR 2 CONDUCTOR #16-2 SHIELDED IN (1) 1 1/2" CONDUIT (1) 4 COND #12 AWG CU (THWN-2) CU TRAY RATED 600V CABLE IN IN (1) 3/4" CONDUIT (1) 3" CONDUIT IT IS A VIOLATION OF LAW FOR ANY PERSON, UNLESS THEY ARE ACTING UNDER THE DIRECTION OF A LICENSED PROFESSIONAL ENGINEER, TO ALTER THIS DOCUMENT. (1) 3/4" PVC CONDUIT (1) TWISTED PAIR OF #18 (SHIELDED, CU, 600V) NY-PI017 (2) TWISTED PAIR GOLDENS BRIDGE (SHIELDED, SAE J1939-11, CU, 600V) NORTH STREET IN (1) 1" CONDUIT **GOLDENS BRIDGE, NY 10526** (1) 1" CONDUIT (2) 262.6 MCM CU (HDFPC-DLO) 2KV + SHEET TITLE (1) #2 AWG CU (HDFPC-DLO) EGC IN EACH OF THE (2) 3" CONDUITS SINGLE LINE DIAGRAM (2) 3" CONDUITS (1) #12 AWG CU (THWN-2) + SHEET NUMBER (1) #12 AWG CU (THWN-2) NEUT + **E-2** (1) #12 AWG CU (THWN-2) EGC IN (1) 3/4" PVC CONDUIT

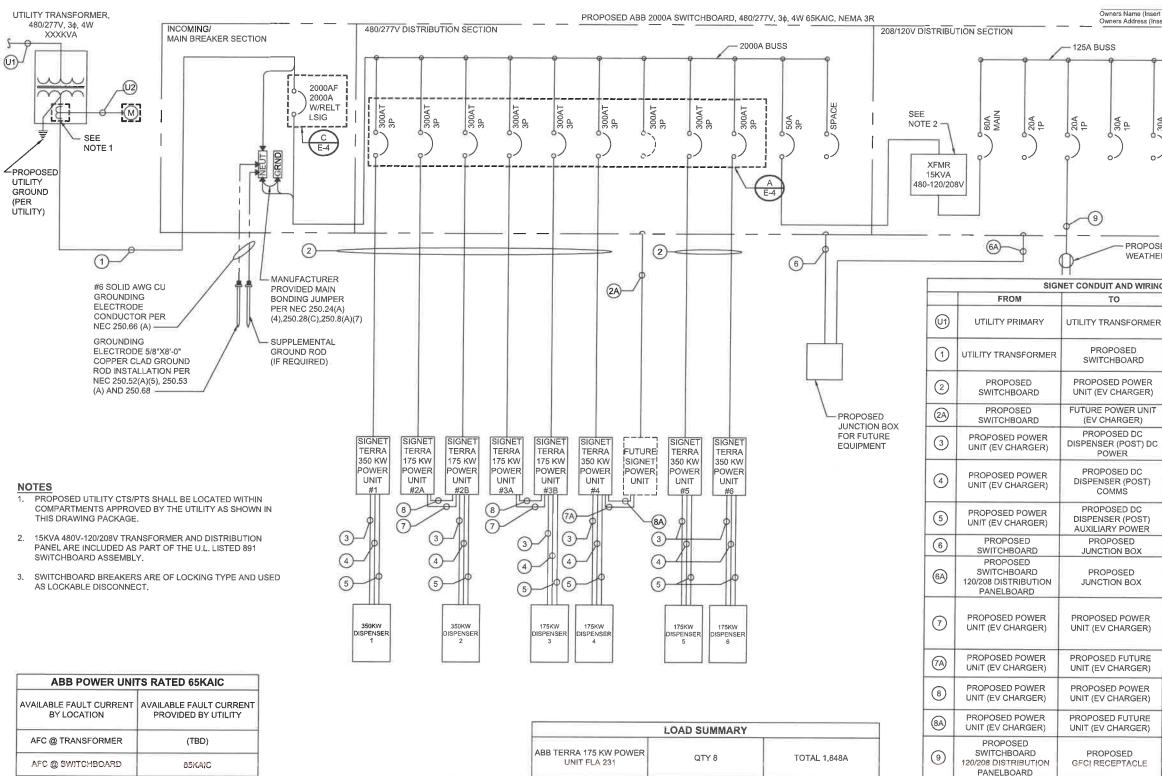


AVAILABLE FAULT CURRENT (AFC) WILL BE (TBD) UNTIL PROVIDED BY UTILITY COMPANY

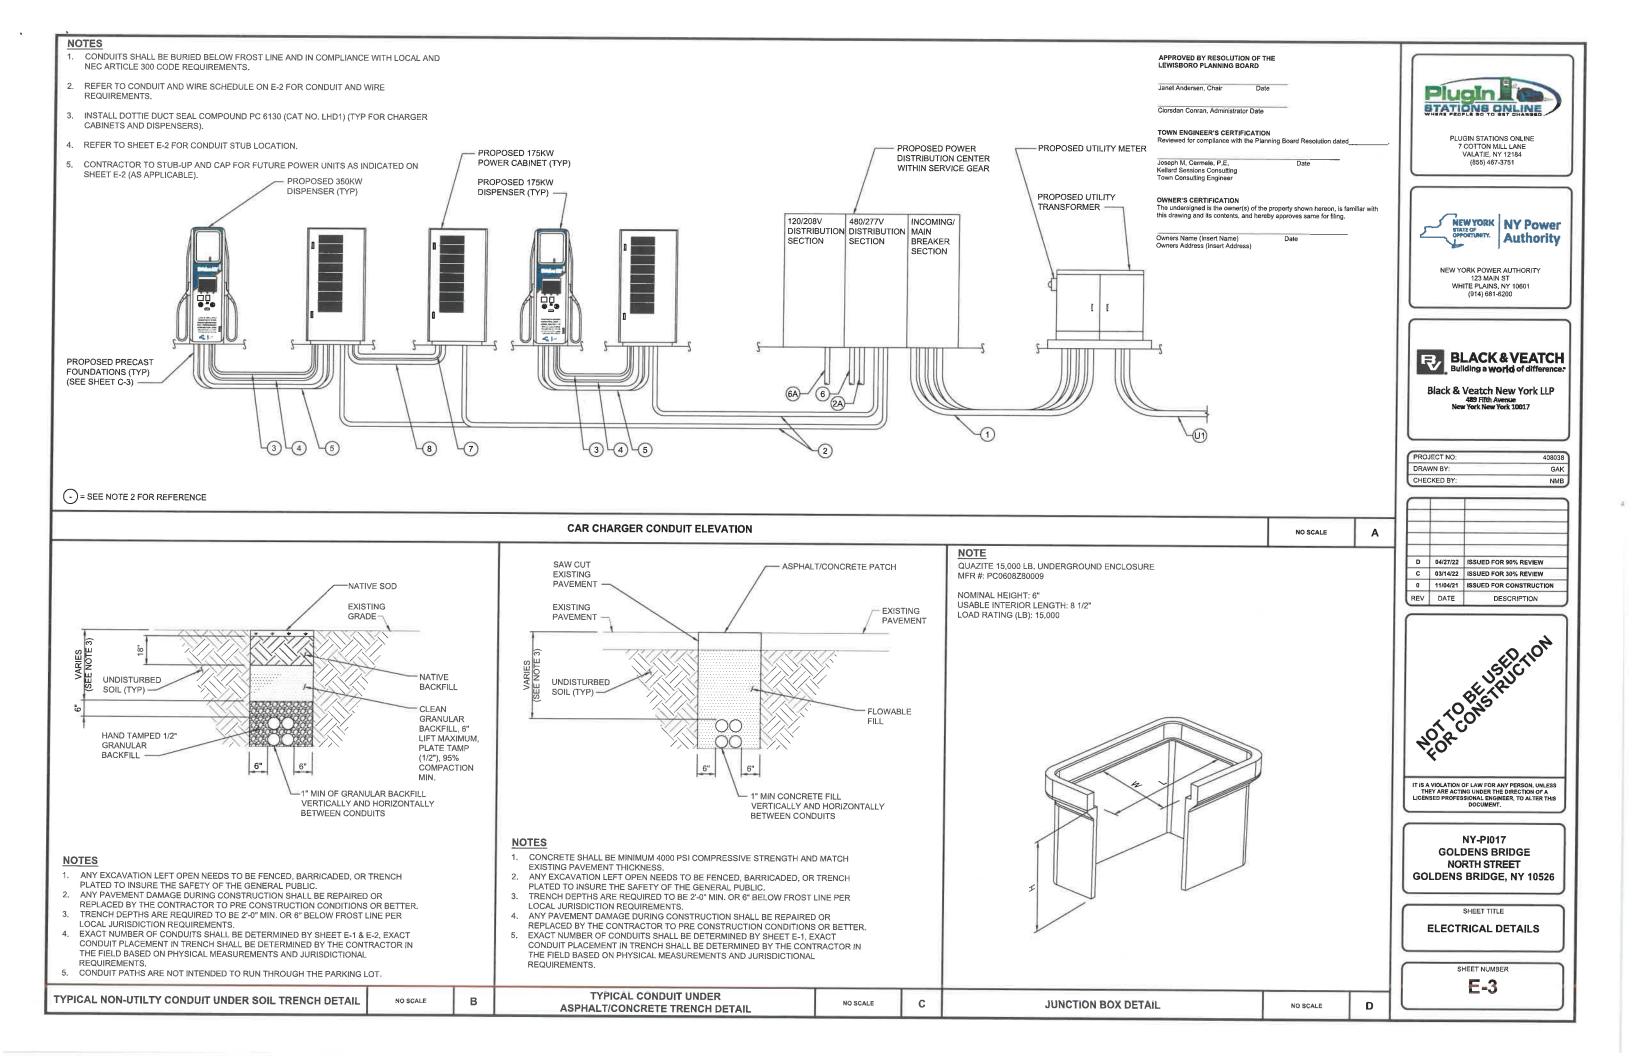

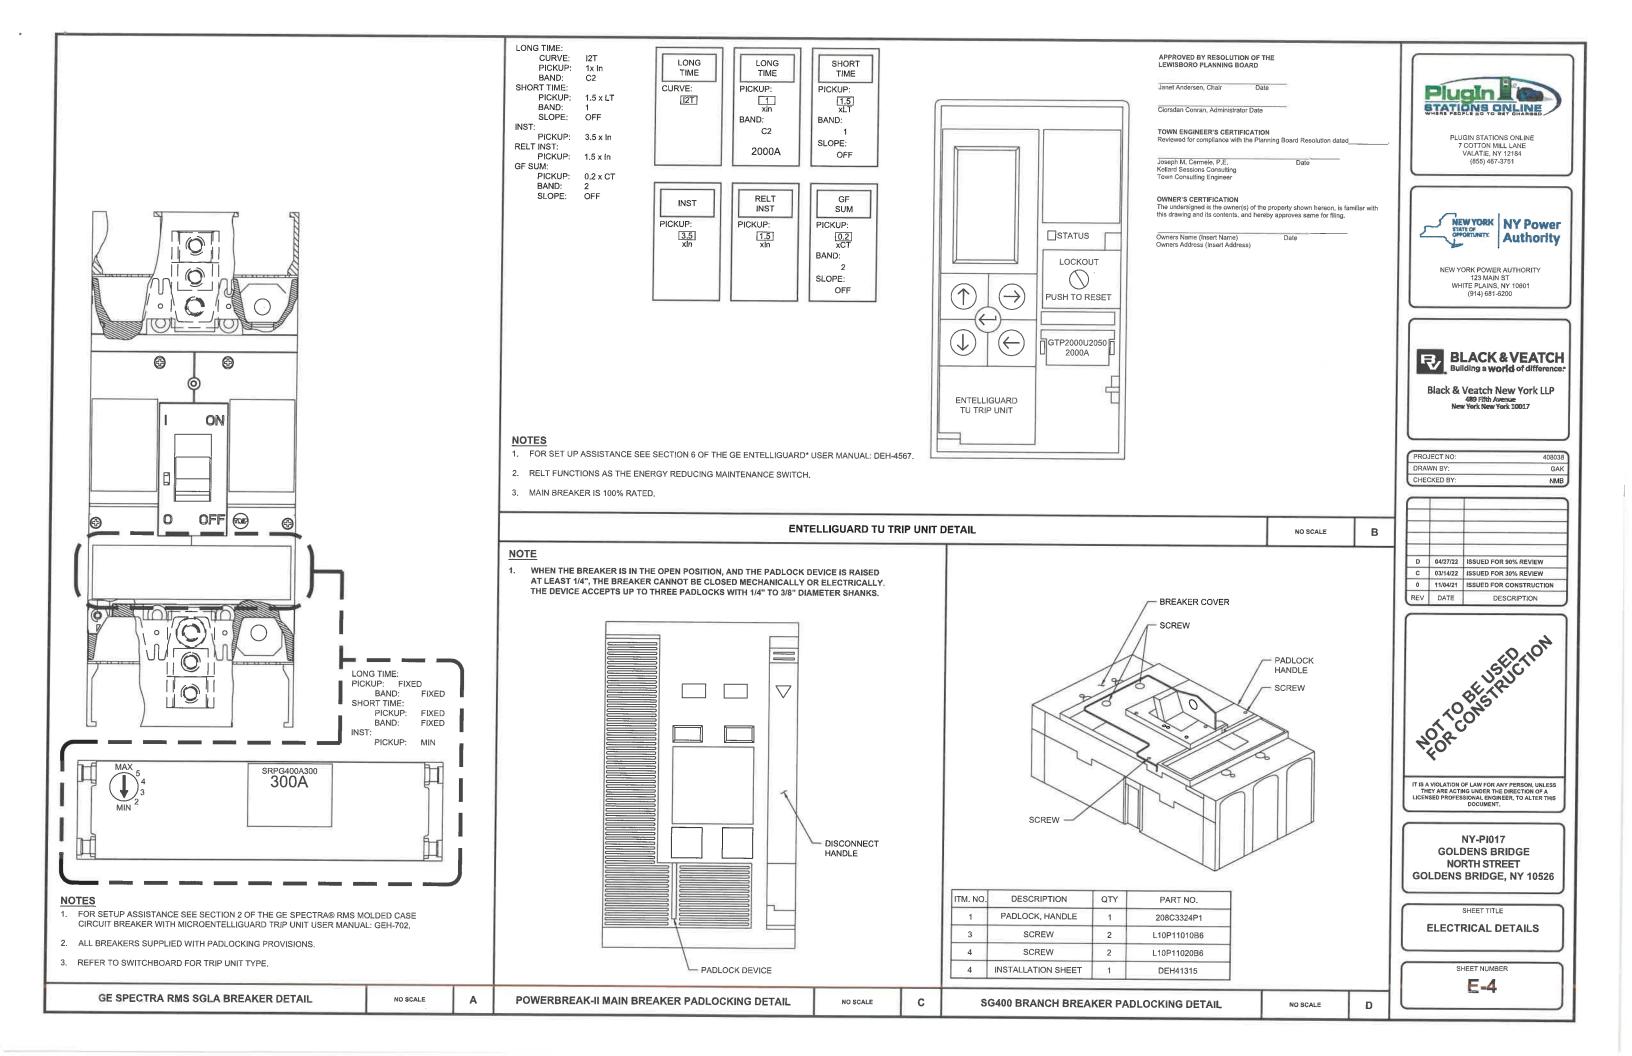


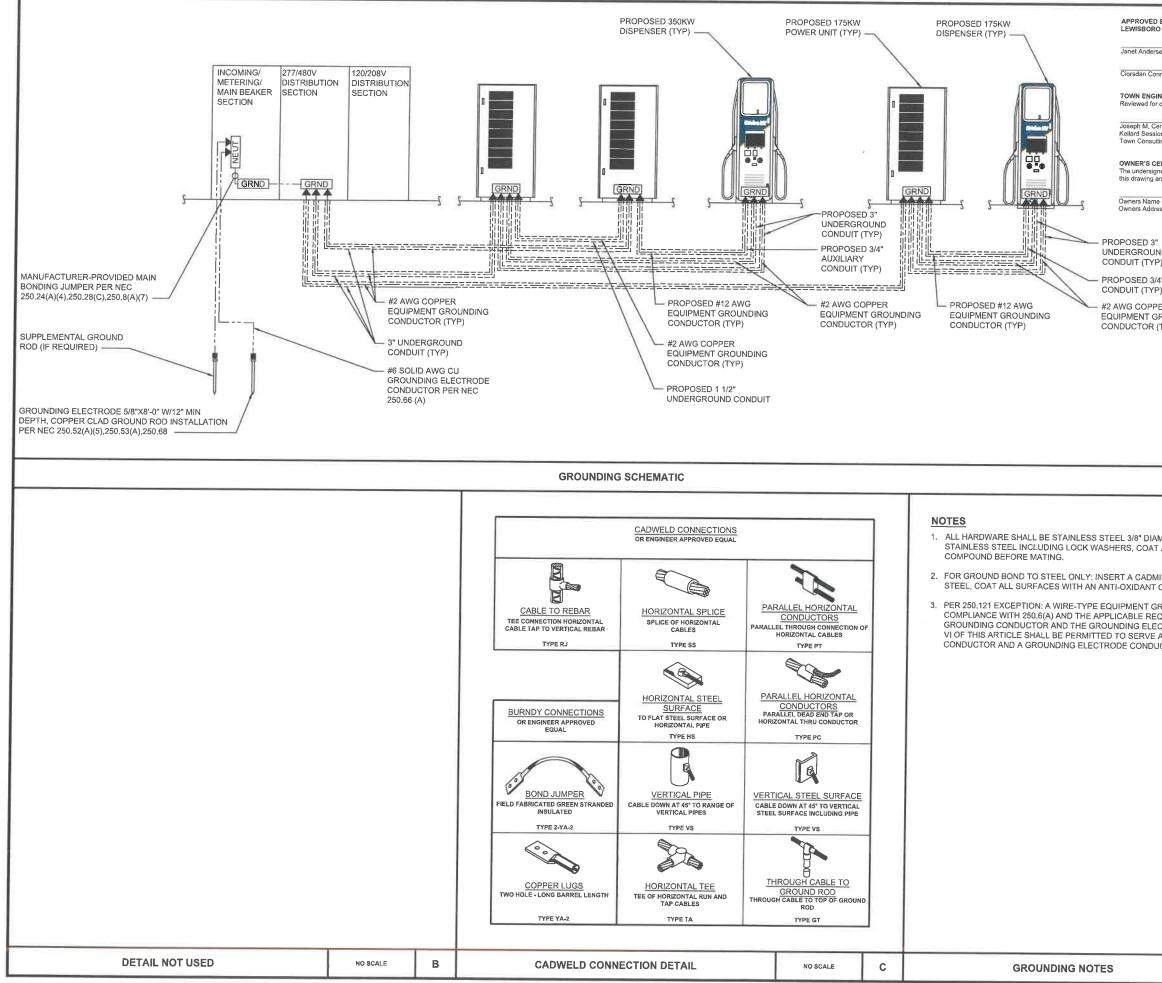


| BY RESOLUTION OF THE PLANNING BOARD an, Chair Date an, Administrator Date tran, Administrator Date terr's CERTIFICATION compilance with the Planning Board Resolution dated treele, P.E. Date t | Number Number Record of the stations online 2000 million Provide the stations online 2000 million |
|--|--|
| , Er Rounding Typ) | BLACK & VEATCH Building a world of difference: Black & Veatch New York LLP 489 Fifth Avenue New York New York 10017 PROJECT NO: 408038 DRAWN BY: GAK CHECKED BY: NMB |
| NO SCALE A | |
| METER OR LARGER. ALL HARDWARE 18-8 ALL SURFACES WITH AN ANTI-OXIDANT IUM FLAT WASHER BETWEEN LUG AND COMPOUND BEFORE MATING. ROUNDING CONDUCTOR INSTALLED IN 20IREMENTS FOR BOTH THE EQUIPMENT CTRODE CONDUCTOR IN PARTS II, III, AND AS BOTH AN EQUIPMENT GROUNDING CTOR. | D 04/27/22 ISSUED FOR 90% REVIEW C 03/4/22 ISSUED FOR 30% REVIEW 0 11/04/21 ISSUED FOR CONSTRUCTION REV DATE DESCRIPTION |
| | IT IS A VIOLATION OF LAW FOR ANY PERSON, UNLESS THEY ARE ACTING UNDER THE DIRECTION OF A LICENSED PROFESSIONAL ENGINEER, TO ALTER THIS DOCUMENT. NY-PI017 GOLDENS BRIDGE NORTH STREET GOLDENS BRIDGE, NY 10526 SHEET TITLE GROUNDING DETAILS |
| NO SCALE D | G-1 |
| | |

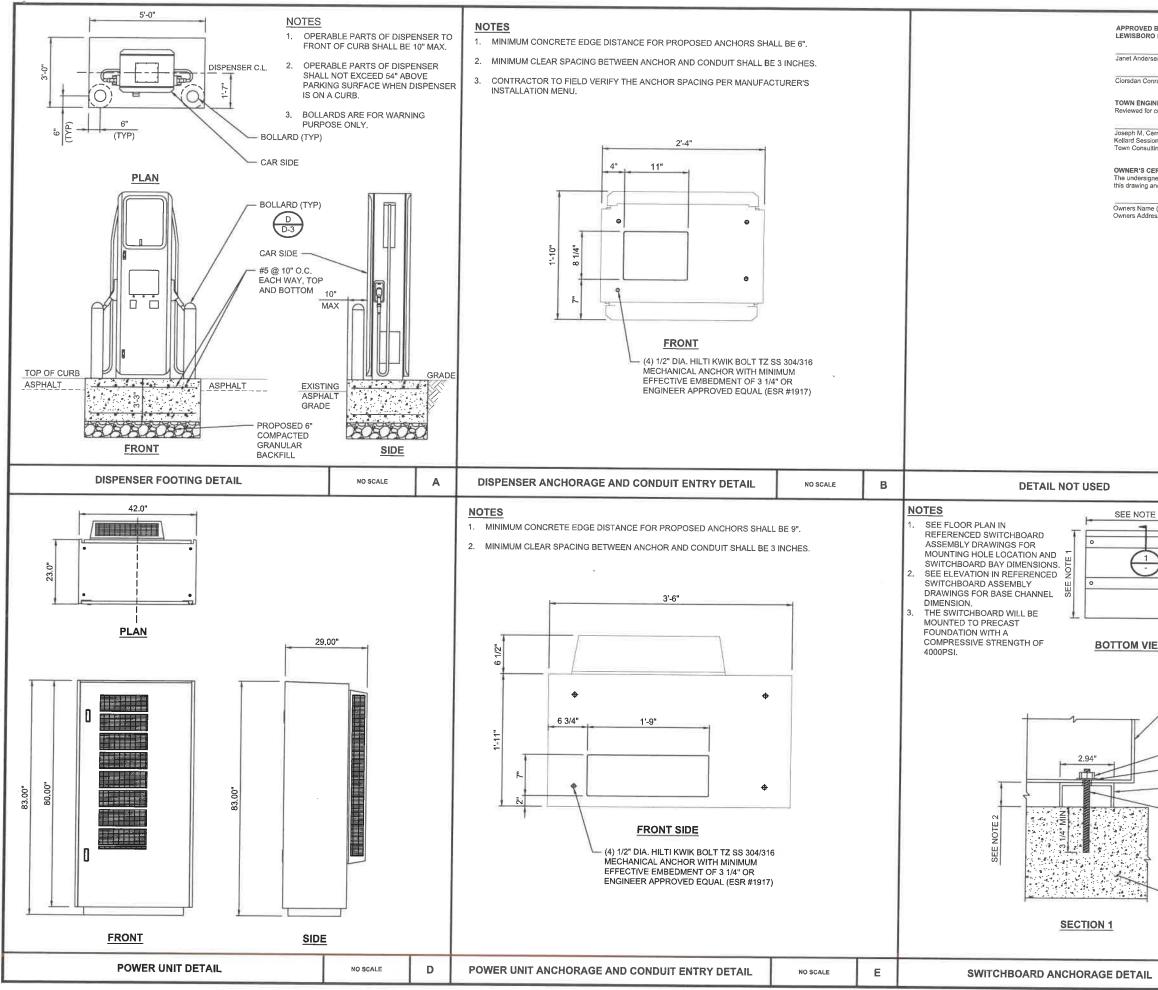

| BY RESOLUTION OF THE PLANNING BOARD | |
|---|---|
| en, Chair Date | Plugin |
| ran, Administrator Date | WHERE PEOPLE BE TO BET DHARGED |
| VEER'S CERTIFICATION compliance with the Planning Board Resolution dated | PLUGIN STATIONS ONLINE 7 COTTON MILL LANE VALATIE, NY 12184 |
| rmele, P.E. Date | (855) 467-3751 |
| ing Engineer | |
| ERTIFICATION led is the owner(s) of the property shown hereon, is familiar with nd its contents, and hereby approves same for filing. | |
| (Insert Name) Date ss (Insert Address) | NEW YORK NY Power Authority |
| | NEW YORK POWER AUTHORITY |
| | 123 MAIN ST WHITE PLAINS, NY 10601 |
| | (914) 681-6200 |
| | |
| | |
| | BLACK & VEATCH Building a world of difference: |
| | Black & Veatch New York LLP 489 Fifth Avenue New York New York 10017 |
| | |
| | PROJECT NO: 408038 |
| | DRAWN BY: GAK |
| | CHECKED BY: NMB |
| | |
| NO SCALE C | |
| 51 | |
| | D 04/27/22 ISSUED FOR 90% REVIEW |
| TYPICAL BOTTOM VIEW LAYOUT | C 03/14/22 ISSUED FOR 30% REVIEW 0 11/04/21 ISSUED FOR CONSTRUCTION |
| OF (1) SWITCHBOARD BAY. SEE NOTE 1 | REV DATE DESCRIPTION |
| | |
| 5/8" DIA. MOUNTING HOLES | NOT TO BELISED TION NOT TO BELISED TION NOT TO BELISED TION NOT TO BELISED TION |
| | |
| FRONT OF SWITCHBOARD BAY | 1 JENC 1 |
| | BETH |
| PROPOSED SWITCHBOARD | TO ME |
| ASSEMBLY CABINET | 1. 5° 2° |
| | 140 |
| HEAVY DUTY NUT | ` |
| BELLEVILLE WASHER | IT IS A VIOLATION OF LAW FOR ANY PERSON, UNLESS THEY ARE ACTING UNDER THE DIRECTION OF A |
| | LICENSED PROFESSIONAL ENGINEER, TO ALTER THIS DOCUMENT. |
| BASE CHANNEL | |
| 1/2" DIA HILTI HAS-R 304/316 SS | NY-PI017 |
| ANCHOR WITH HILTI HIT-RE 500V EPOXY & MINIMUM EFFECTIVE | GOLDENS BRIDGE NORTH STREET |
| EMBEDMENT OF 3 1/4", OR ENGINEER APPROVED | GOLDENS BRIDGE, NY 10526 |
| EQUAL (ESR# 3814) (TYP OF 12) | |
| | SHEET TITLE |
| PROPOSED CONCRETE SLAB | EQUIPMENT DETAILS |
| | |
| | SHEET NUMBER |
| | D-1 |
| NO SCALE | |

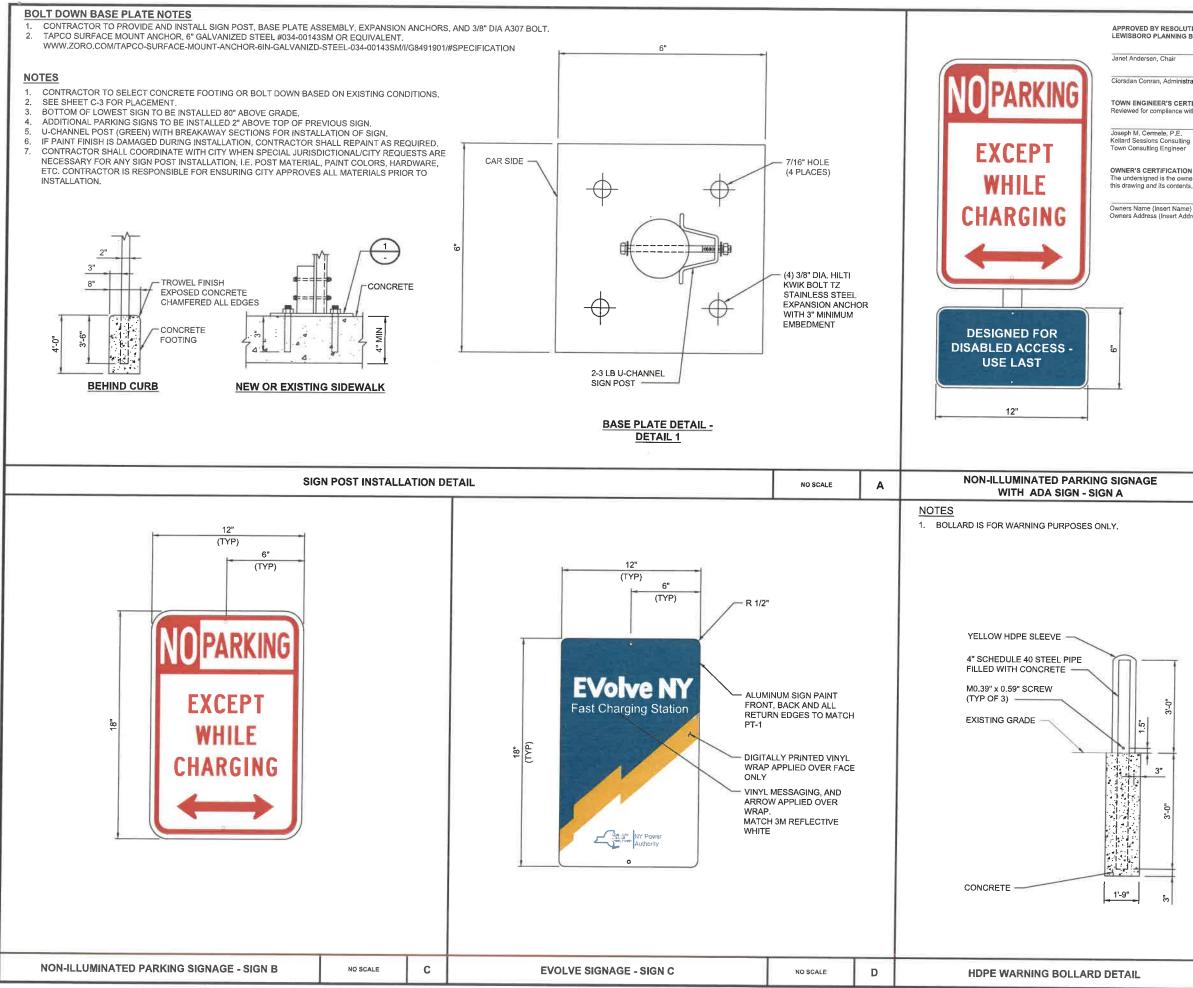


APPROVED BY RESOLUTION OF THE LEWISBORO PLANNING BOARD Date Pluain STATIONS ONLINE Ciorsdan Conran, Administrator Date TOWN ENGINEER'S CERTIFICATION PLUGIN STATIONS ONLINE Reviewed for compliance with the Planning Board Resolution dated 7 COTTON MILL LANE VALATIE, NY 12184 (855) 467-3751 Date The undersigned is the owner(s) of the property shown hereon, is familiar with this drawing and its contents, and hereby approves same for filing. NEWYORK NY Power STATE OF OPPORTUNETY. Owners Name (Insert Name) Owners Address (Insert Address) Authority Date NEW YORK POWER AUTHORITY 123 MAIN ST WHITE PLAINS, NY 10601 (914) 681-6200 Building a world of differ Black & Veatch New York LLP 489 Fifth Avenue New York New York 10017 PROJECT NO: 408038 DRAWN BY: GAK CHECKED BY: NMB NO SCALE в D 04/27/22 ISSUED FOR 90% REVIEW C 03/14/22 ISSUED FOR 30% REVIEW 0 11/04/21 ISSUED FOR CONSTRUCTION REV DATE DESCRIPTION BESTRUCTION IT IS A VIOLATION OF LAW FOR ANY PERSON, UNLESS THEY ARE ACTING UNDER THE DIRECTION OF A LICENSED PROFESSIONAL ENGINEER, TO ALTER THIS DOCUMENT. 3" NY-PI017 GOLDENS BRIDGE NORTH STREET **GOLDENS BRIDGE, NY 10526** SHEET TITLE š **EQUIPMENT DETAILS** SHEET NUMBER **D-2** NO SCALE Е

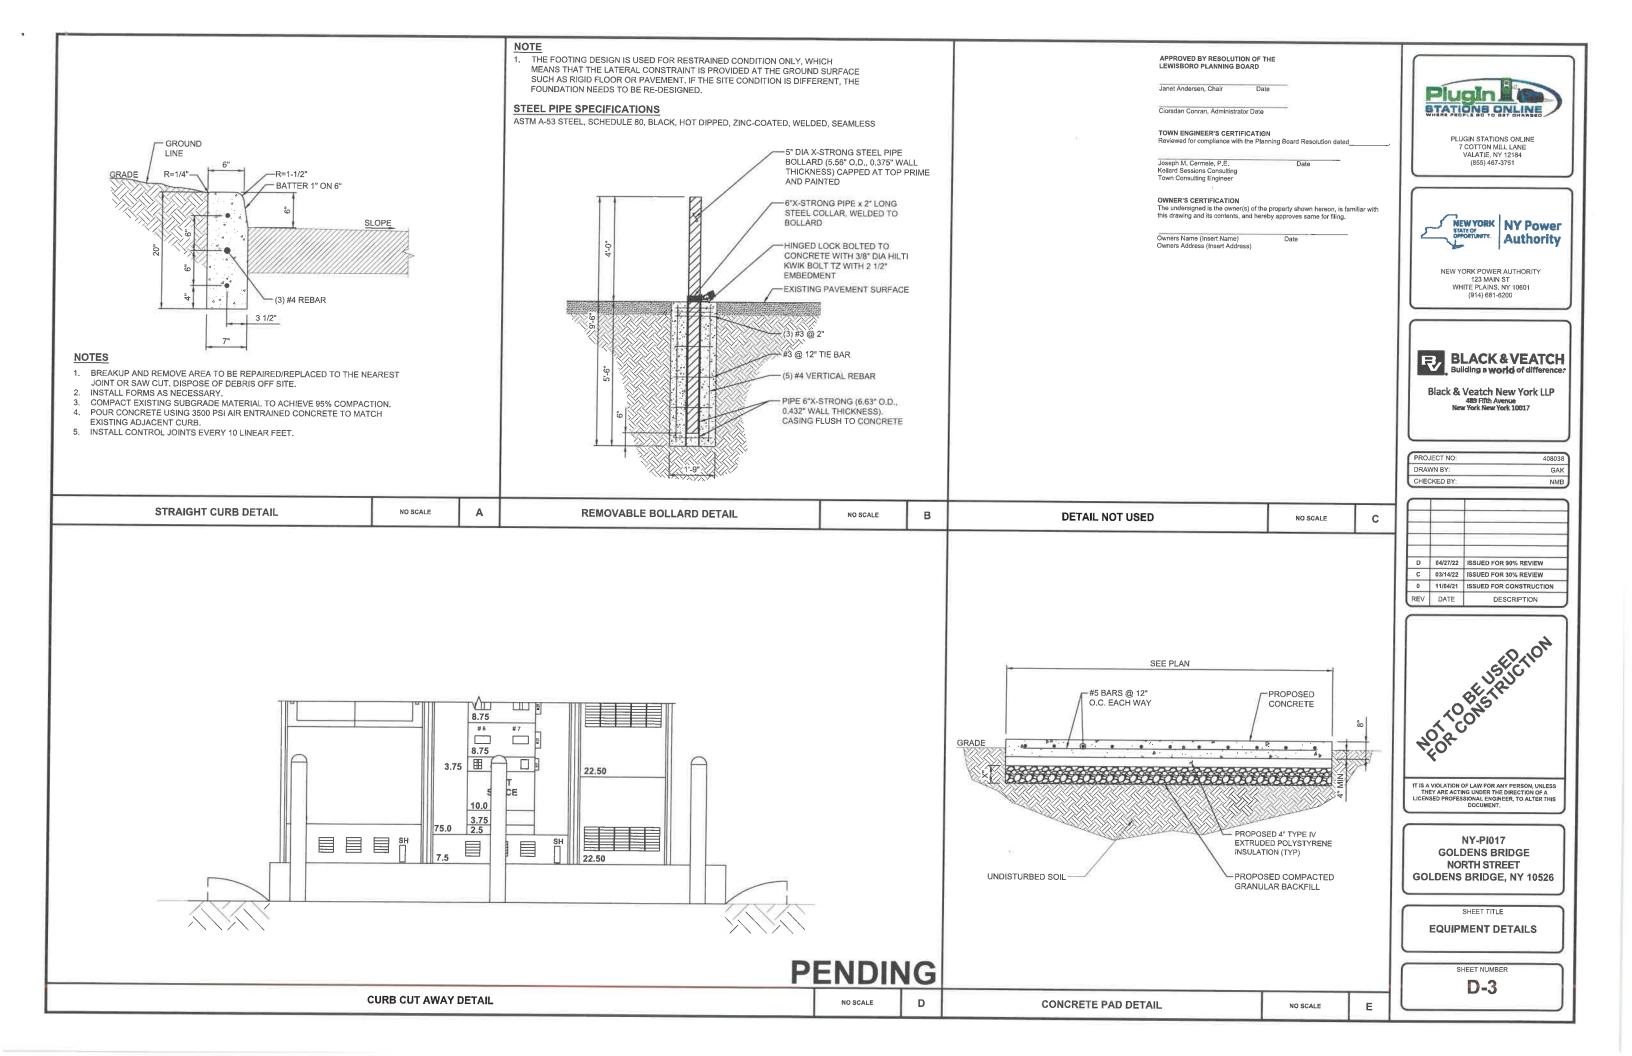

NOTES

- 1. THE UTILITY DESIGN DETAILS SUMMARIZED ON THIS SHEET ARE FOR PROPERTY OWNER REVIEW. THE CONTRACTOR SHALL REFERENCE THE FINAL UTILITY DESIGN PROVIDED BY THE UTILITY FOR BIDDING. THE CONTRACTOR SHALL INSTALL THE UTILITY RELATED SCOPE OF WORK PER UTILITY CONSTRUCTION SPECIFICATION REQUIREMENTS. THE ELECTRIC UTILITY DESIGN SHALL SUPERSEDE ALL OTHER INFORMATION.
- 2. UTILITY EQUIPMENT INSTALLATIONS AND PREP WORK AND TERMINATION OF SERVICE CONDUCTORS SHALL BE COORDINATED WITH THE APPROPRIATE UTILITY ENGINEER AT TIME OF PRE-CONSTRUCTION MEETING TO ENSURE ACCURACY OF INSTALLATIONS.

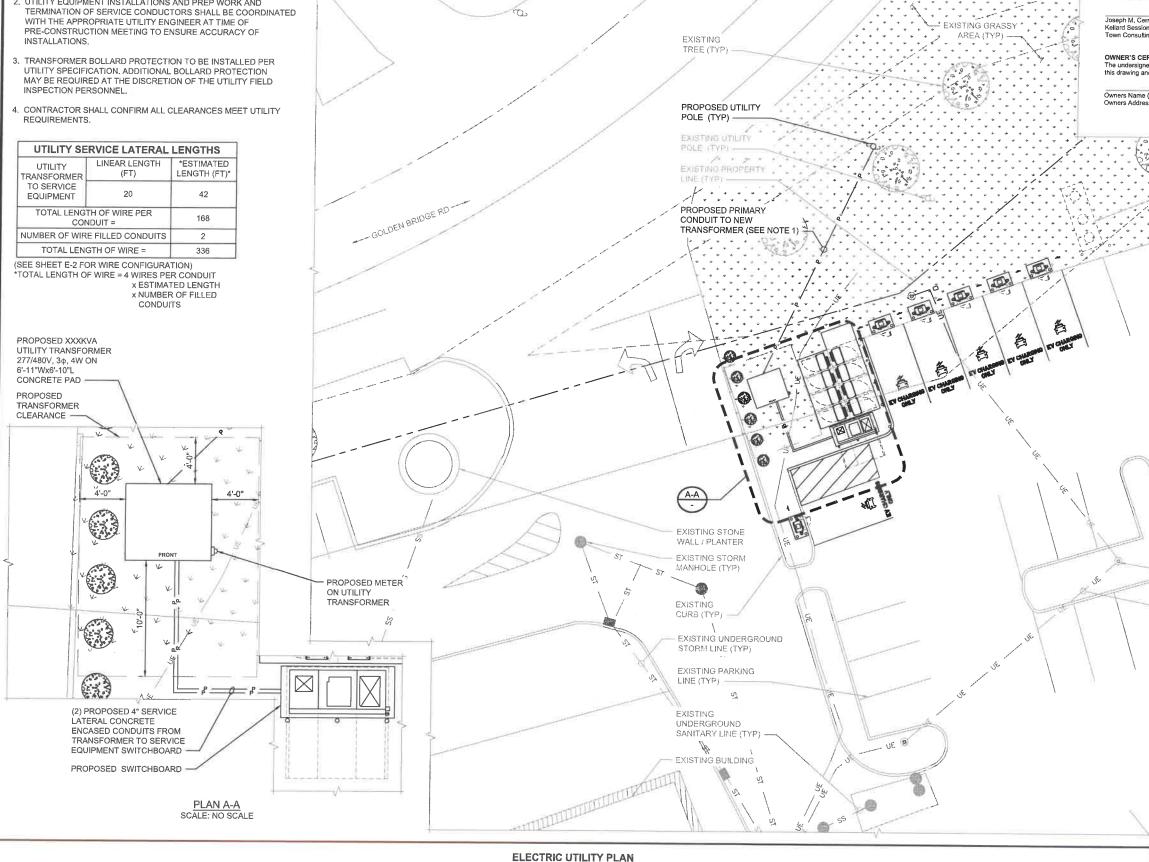

APPROVED BY RESOLUTION OF THE LEWISBORO PLANNING BOARD Janet Andersen, Chair Date Plualn STATIONS ONLINE Ciorsdan Conran, Administrator Date TOWN ENGINEER'S CERTIFICATION PLUGIN STATIONS ONLINE Reviewed for compliance with the Planning Board Resolution da 7 COTTON MILL LANE VALATIE, NY 12184 Joseph M, Cermele, P,E, Kellard Sessions Consulting Town Consulting Engineer (855) 467-3751 OWNER'S CERTIFICATION The undersigned is the owner(s) of the property shown hereon, is familiar with this drawing and its contents, and hereby approves same for filing. NEWYORK NY Power Authority Owners Name (Insert Name) Owners Address (Insert Address) Date NEW YORK POWER AUTHORITY 123 MAIN ST WHITE PLAINS, NY 10601 (914) 681-6200 - - - - -- - - -- U/G PROPANE TANK . (ESTIMATED SIZE) Building a world of difference Black & Veatch New York LLP 489 Fifth Avenue New York New York 10017 PROJECT NO: 408038 DRAWN BY GAK CHECKED BY NMB D 04/27/22 ISSUED FOR 90% REVIEW C 03/14/22 ISSUED FOR 30% REVIEW 0 11/04/21 ISSUED FOR CONSTRUCTION REV DATE DESCRIPTION EXISTING LIGHT POLE (TYP) EXISTING UNDERGROUND ELECTRIC LINE (TYP) NY-PI017 **GOLDENS BRIDGE** NORTH STREET **GOLDENS BRIDGE, NY 10526** SHEET TITLE ELECTRIC UTILITY PLAN SHEET NUMBER

1"=10"

à. * *